

EXTERIOR WALL PANEL ASSEMBLY DRAWINGS
FOR THE:

Newtown Road Townhomes

USING THE



THERMASTEEL[™]
ADVANCED PANEL SYSTEMS

WALLFRAME SYSTEM

MANUFACTURED BY

ThermaSteel Inc.
609 West Rock Road
Radford, VA 24141
540-633-5000

General Notes:

- * The drawings herein are manufacturing and assembly drawings. The contractor/ owner shall be solely responsible for verifying all dimensions, site conditions and all state and local code requirements are met.
- * ThermaSteel wall panels are to be 5 1/2" thick with 24 GA T/S metal @ 16" O.C., unless noted.
- * All walls are to receive metal track, top & bottom, per engineering specs.
- * All door and window openings are per contractor / owner.
- * All rough openings are to have metal surrounds.
- * All engineering of the structure, Including the ThermaSteel specifications, is to be completed and/or approved by the Project Engineer/Engineer of Record. If buyer decides not to use engineering and structural design services (which have an additional fee), buyer shall assume all responsibility and liability for the structure and the seller shall have no liability in relation thereto.
- * Contractor is to confirm that all rough openings meet local egress and minimum light and ventilation requirements.
- * Contractor is to refer to the architectural prints for all information not provided by ThermaSteel.
- * ThermaSteel will provide reasonable technical assistance as requested with regards of the use of the ThermaSteel Building System.
- * ThermaSteel will provide panel layout drawings (shop drawings) for the installation of panels, special panel requirements (if any), requirements for attachment and connection details for ThermaSteel panels.
- * ThermaSteel shop drawings are based on the architectural prints provided by the customer.
- * All electrical, plumbing, HVAC, additional mechanical systems, exterior and interior finished and etc. is the responsibility of the contactor/ owner.
- * For panel properties visit <http://thermasteelinc.com/content/revpanel-system>

Below Grade Application Notes:

- * For below grade application design criteria and installation manual download information at link below.
http://thermasteelinc.com/sites/default/files/documents/Below_grade_application_0.pdf

ABBREVIATIONS

@	At	L.F.	Linear Foot / Linear Feet
A.F.F.	Above Finish Floor	L.V.L.	Laminated Veneer Lumber
"C"	Metal "C"	MAX.	Maximum
C.J.	Ceiling Joist	MIN.	Minimum
CMU	Concrete Masonry Unit	MISC.	Miscellaneous
CONC.	Concrete	NLE	No Leading Edge
COR.	Corner	NLL	No Lap Left
DIA.	Diameter	NLR	No Lap Right
ENG.	Engineer / Engineering	NOM.	Nominal
EXT.	Exterior	O.C.	On Center
F.J.	Floor Joist	OPT.	Optional
FT.	Foot / Feet	P.T.	Pressure Treated
FTG.	Footing	RAD.	Radius
GA	Gauge	SF	Square Foot / Square Feet
HDR.	Header	SQ.	Square
INT.	Interior	SPEC.	Specification
INSUL.	Insulation / Insulated	TYP.	Typical
JST.	Joist	W/	With
"L"	Metal "L"	W.W.M.	Welded Wire Mesh


Additional Compliance Reports

HUD - Bulletin # 1072
UL-File NC 554
South Florida - HTL98072
Florida Product Approval - FL3859-R2

Building Code Listings

IAPMO - Report # ER-128

THE DRAWINGS HEREIN ARE MANUFACTURING DRAWINGS ONLY. CONTRACTOR SHALL BE SOLELY RESPONSIBLE FOR VERIFYING ALL DIMENSIONS, SITE CONDITIONS, AND THAT ALL STATE AND LOCAL CODE REQUIREMENTS ARE MET.
THERMASTEEL BUILDING SYSTEMS - MANUFACTURED BY THERMASTEEL RP Ltd. - WEST ROCK ROAD RADFORD, VA 24141
PHONE (540) 633-5000 FAX (540) 633-5001 www.thermasteelinc.com

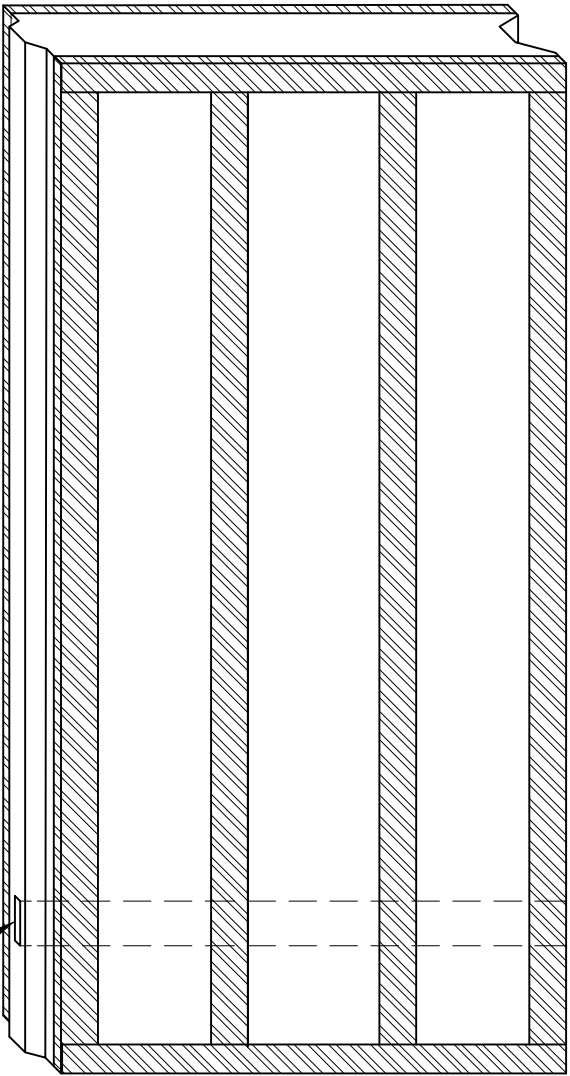

HORIZONTAL
WIRECHASE

11" (TYP)

TYPICAL WIRECHASE LOCATION

PANEL AS VIEWED FROM OUTSIDE
OF THE STRUCTURE

FINISH DATE:	5/12/2022
REVISION:	
DRAWN:	PLiu
DESIGNED:	
SCALE:	NTS
JOB NUMBER	21-245C
COVER	

FINAL DRAWING APPROVAL LETTER

Dear Client,

Enclosed is the completed final production drawing package for your project.

Please take the time to ensure the ThermaSteel drawing package is exactly as you need for your project.
Note: These drawings are the assembly drawings as well.

- Architect, contractor and/or client please review and approve/sign:
Overall wall layout, project elevations, panel heights, lengths and placement of panel types (thickness 3.5"; 5.5" or 7.5"). Rough opening height, width and placement for doors, windows, AC units, etc. Verify all relevant connection details are attached and if any additional details are required.
- Engineer please review and approve/sign :
Panel type (thickness 3.5"; 5.5" or 7.5"), panel density (1pcf or 1.5pcf), gage of steel stud to be used, stud type (track or CSJ), special items such as hold downs, cut outs, bracing, shear bracing, jack studs, king studs, headers, boxed beam headers, sills, beams, and all materials looking for sizing, spacing, placement and adequacy for design criteria. Verify all relevant connection details are attached and if any additional details are required. All connections to other building elements not provided by ThermaSteel. All screw connections, screw types, connection patterns etc.
- Please confirm the general correctness and conformity of your project to the provided design criteria and your satisfaction.


If changes are needed, please mark these changes directly on the drawings and email back to ThermaSteel. If all drawings are satisfactory, please sign and date each sheet of the drawing package and email them to ThermaSteel. Your project will not be released to accounting and/or production without signatures and dates on each sheet. Once signed, dated and received by ThermaSteel, the drawings become final. A final invoice and a production payment request will be issued following your approval. The final cost of your project will be calculated based on approved shop drawing package.

Client acknowledges that shop drawings may include some items that are not provided by ThermaSteel such as: AC units, ducts, hold downs, etc. Please ask your sales representative if you have any questions concerning your project.


Changes to the aforementioned items after the receipt of this signed drawing package by ThermaSteel will be subject to a change order and subsequent fees.

Thank you,

Paul Liu
Design & Drafting Department

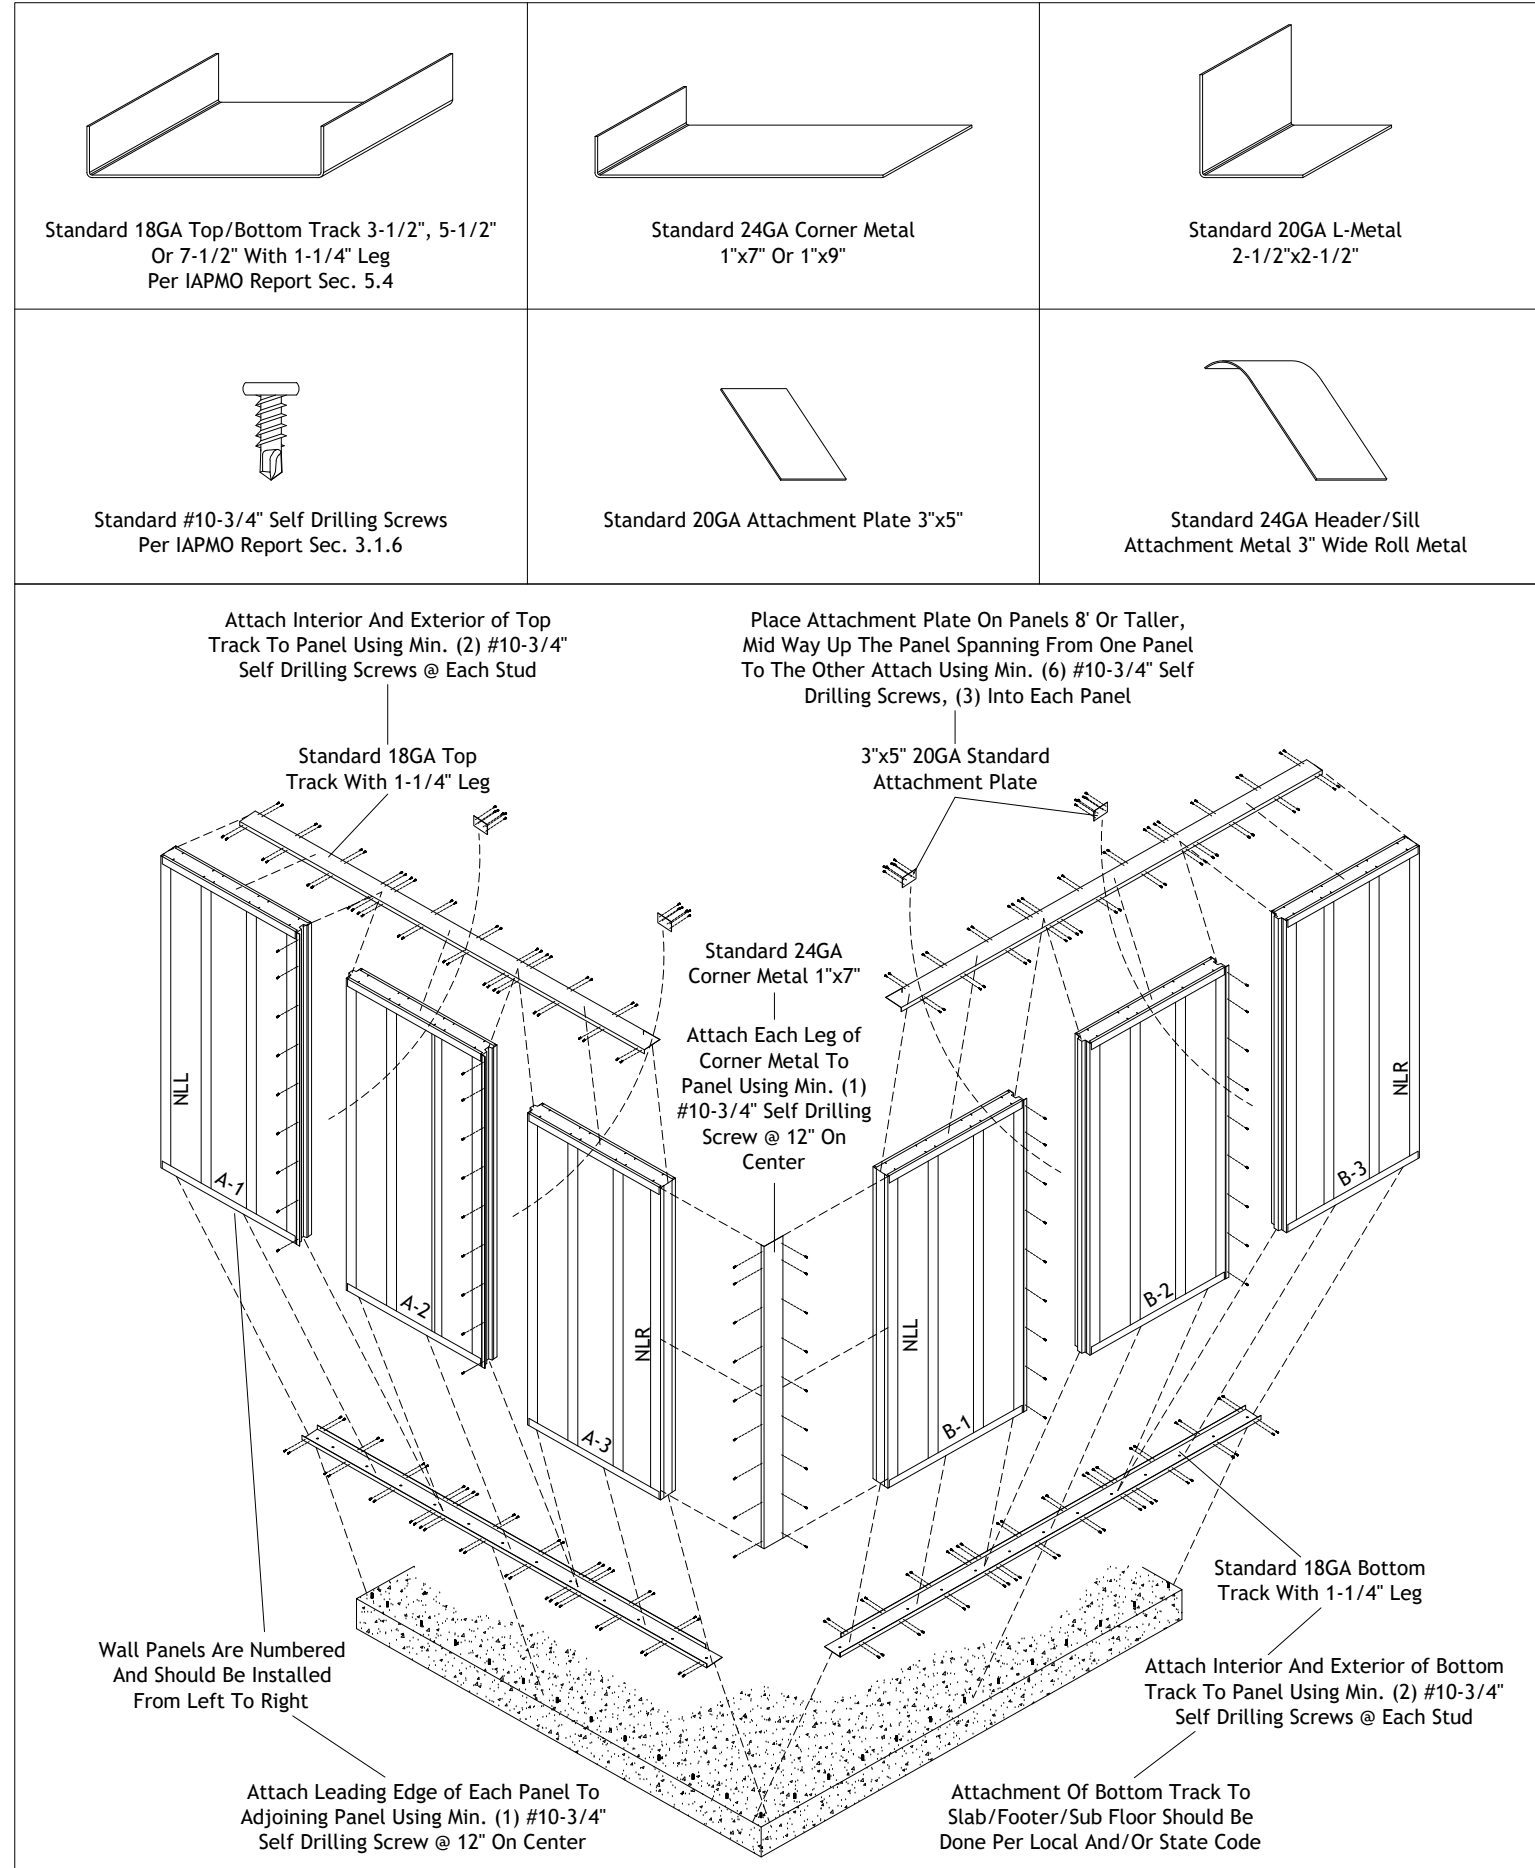

Newtown Road Townhomes

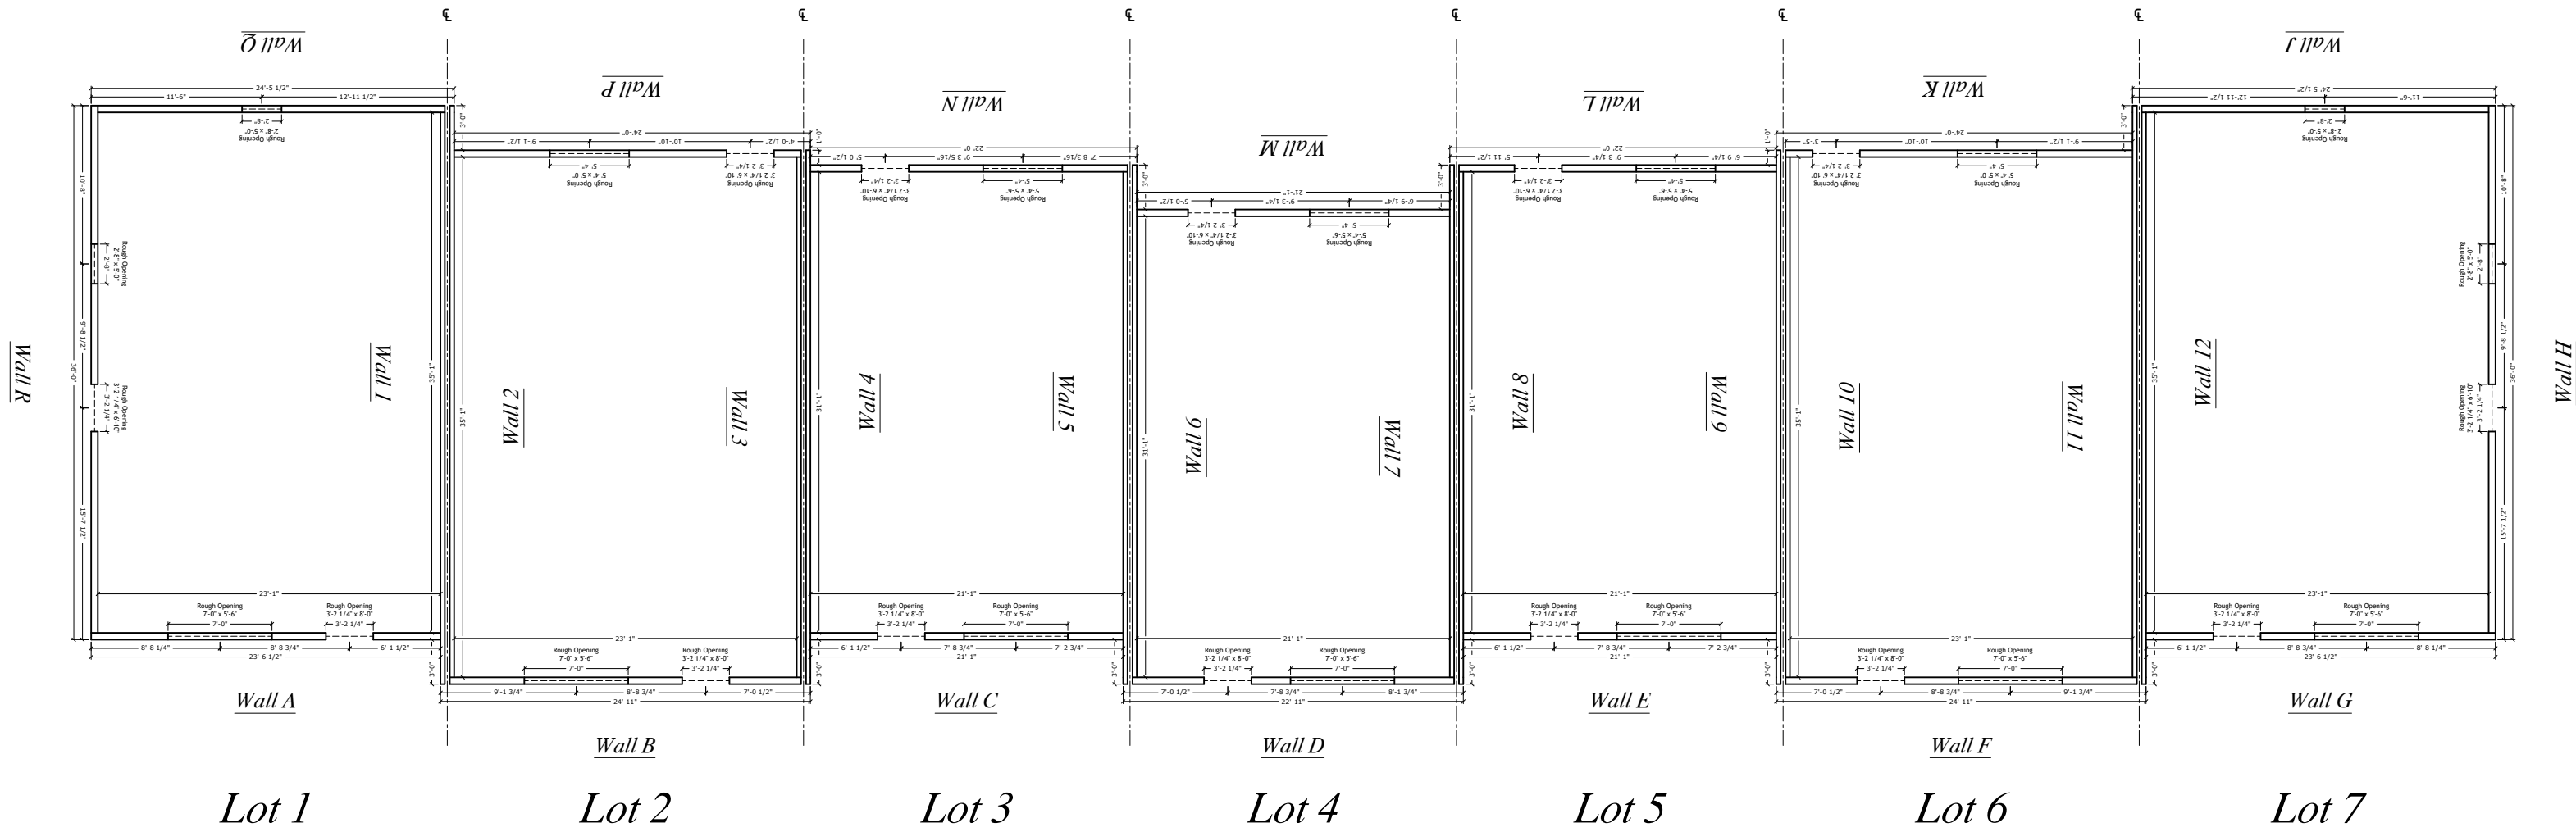

Newtown Road Townhomes (1st Floor Plan - Lots 1 - 7)


All engineering of the structure, including the ThermoSteel Building System specifications, is to be completed and/or approved by the Project Engineer and/or the Engineer of Record.
THERMASTEEL WALLFRAME SYSTEMS - MANUFACTURED BY THERMASTEEL Inc. - 609 WEST ROCK ROAD RADFORD, VA 24141 - PHONE (540) 633-5000, FAX (540) 633-5001 www.thermasteelinc.com
THE DRAWINGS HEREIN ARE PANEL MANUFACTURING DRAWINGS ONLY. CONTRACTOR SHALL BE SOLELY RESPONSIBLE FOR VERIFYING ALL DIMENSIONS, SITE CONDITIONS, AND THAT ALL STATE AND LOCAL CODE REQUIREMENTS ARE MET.

FINISH DATE:	5/12/2022
REVISION:	
SCALE:	NTS
DESIGNED:	
DRAWN:	PLiu

**THERMASTEEL**
ADVANCED PANEL SYSTEMS

21-245C
JOB NUMBER

SHEET
FP-1

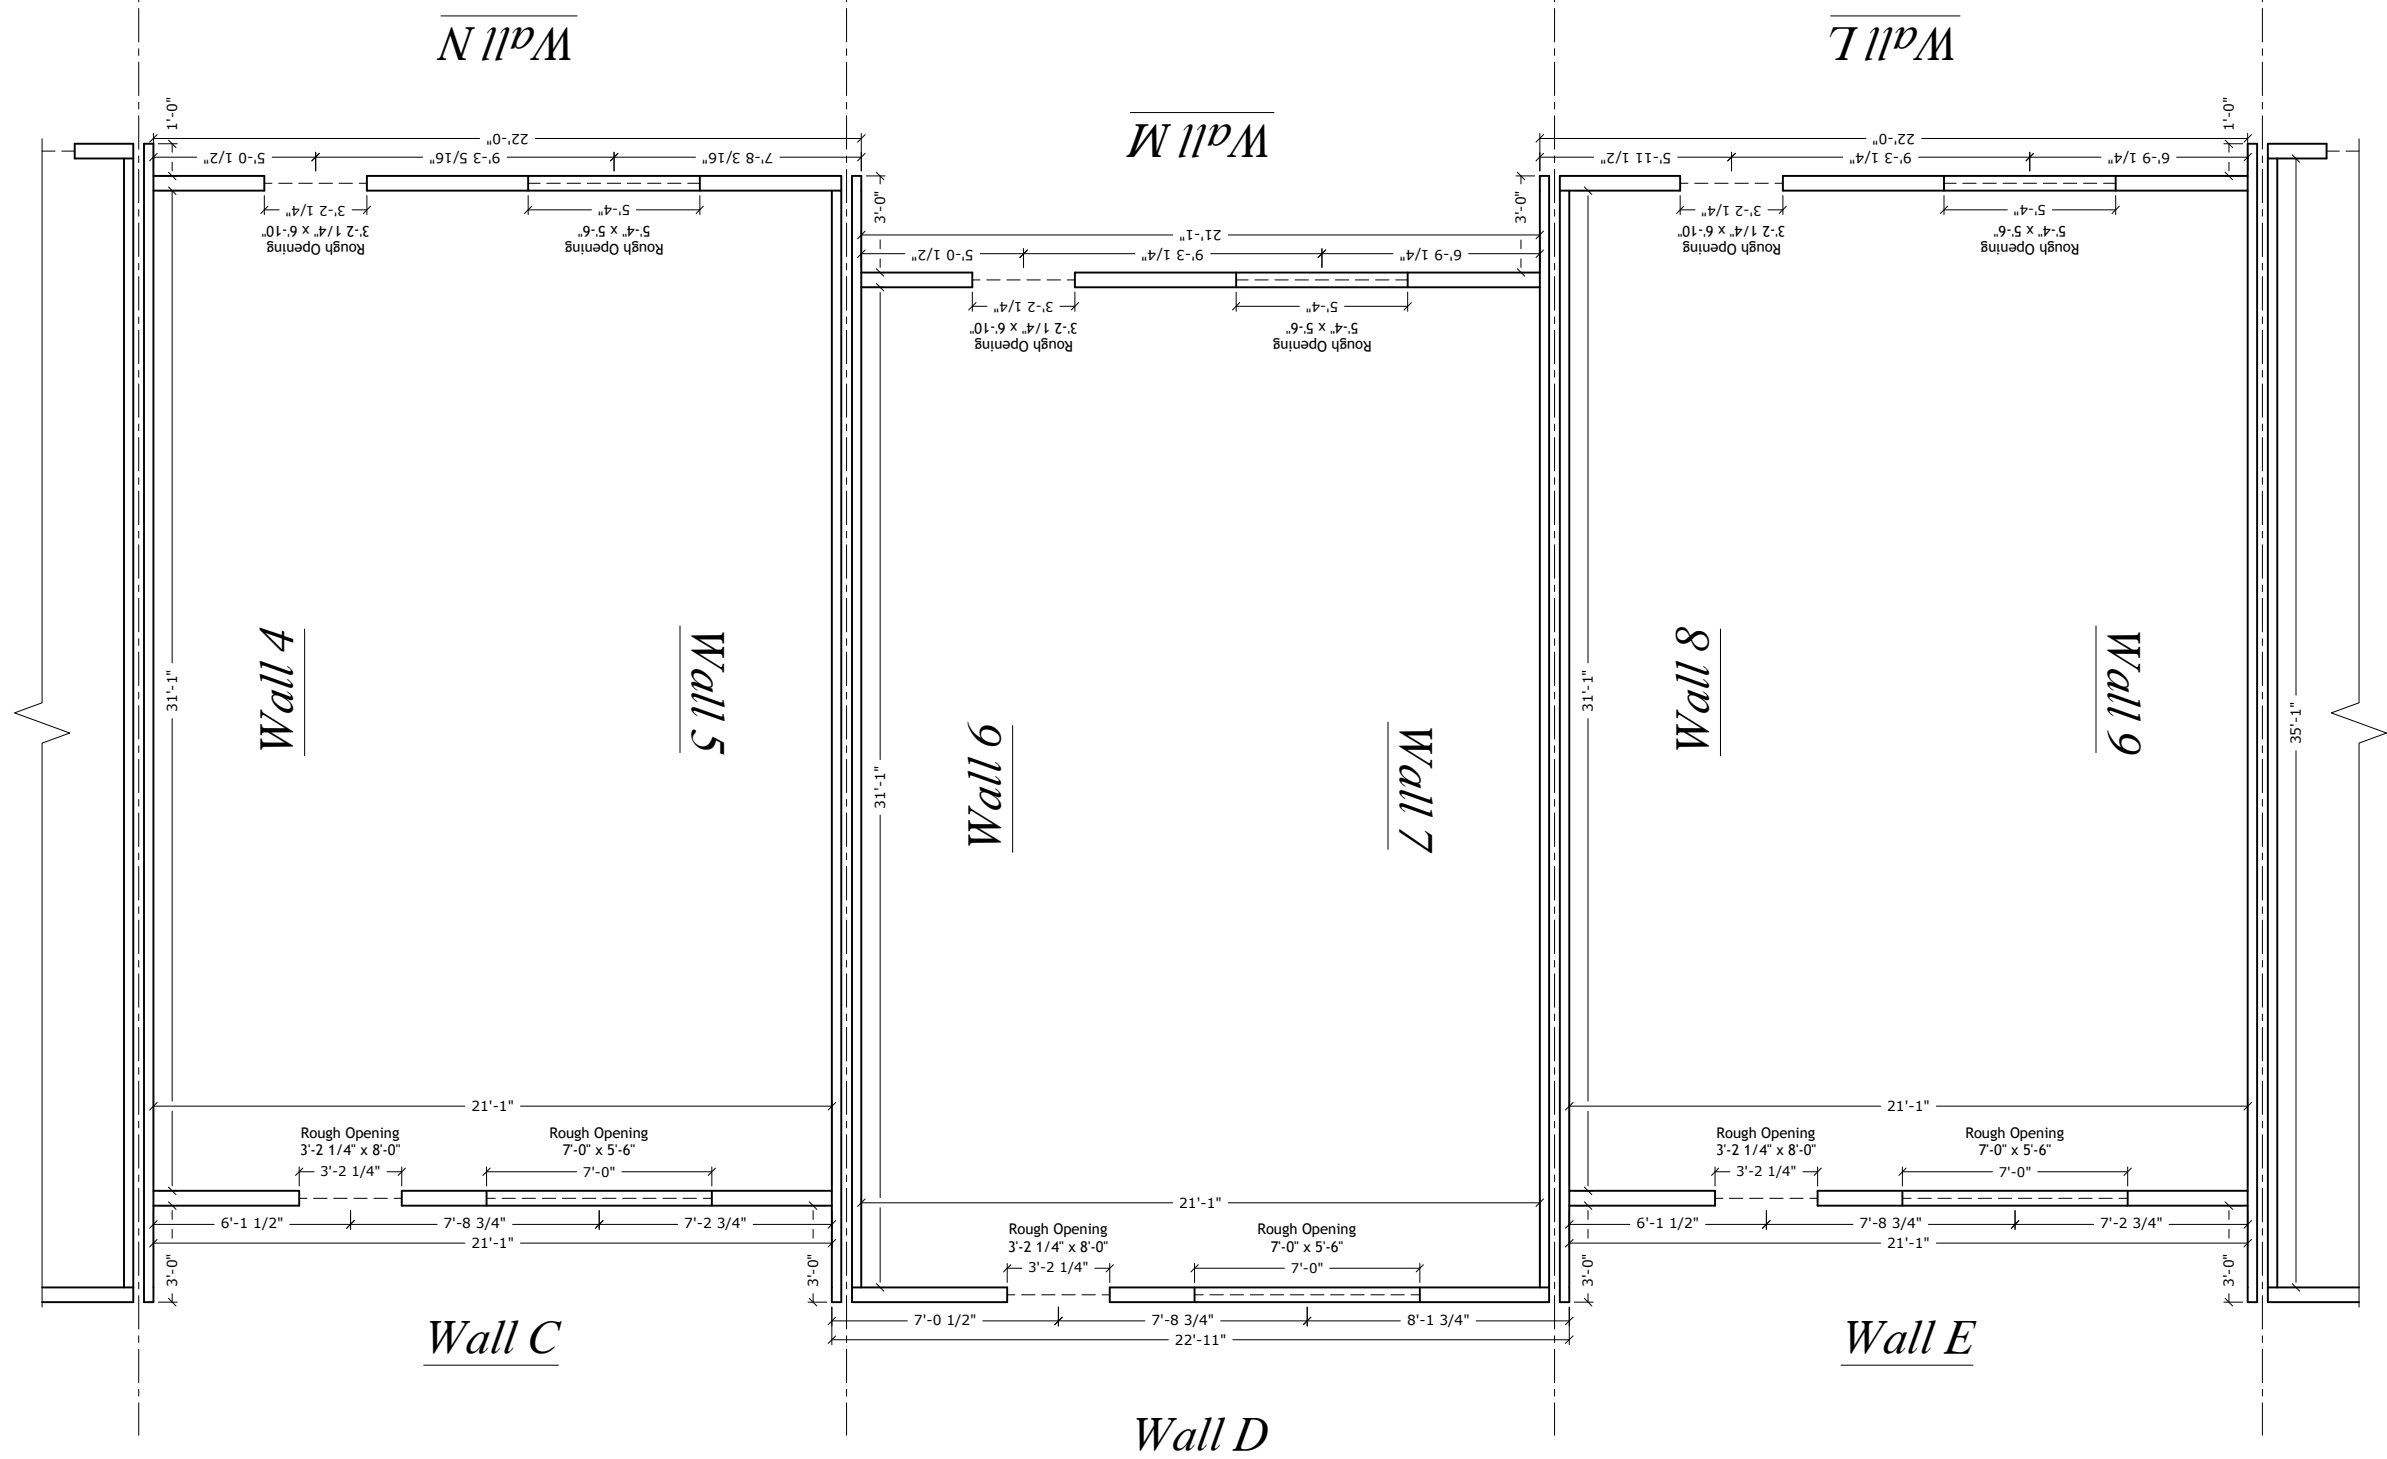

Lot 3

Lot 4

Lot 5

Newtown Road Townhomes (1st Floor Plan - Lots 3 - 5)


All engineering of the structure, including the ThermoSteel Building System specifications, is to be completed and/or approved by the Project Engineer and/or the Engineer of Record.
THERMASTEEL WALLFRAME SYSTEMS - MANUFACTURED BY THERMASTEEL Inc. - 609 WEST ROCK ROAD RADFORD, VA 24141 - PHONE (540) 633-5000, FAX (540) 633-5001 www.thermasteelinc.com
THE DRAWINGS HEREIN ARE PANEL MANUFACTURING DRAWINGS ONLY. CONTRACTOR SHALL BE SOLELY RESPONSIBLE FOR VERIFYING ALL DIMENSIONS, SITE CONDITIONS, AND THAT ALL STATE AND LOCAL CODE REQUIREMENTS ARE MET.

FINISH DATE:	5/12/2022
REVISION:	
SCALE:	NTS
DESIGNED:	
DRAWN:	PLiu

**THERMASTEEL™**
ADVANCED PANEL SYSTEMS

21-245C
JOB NUMBER

SHEET
FP-3

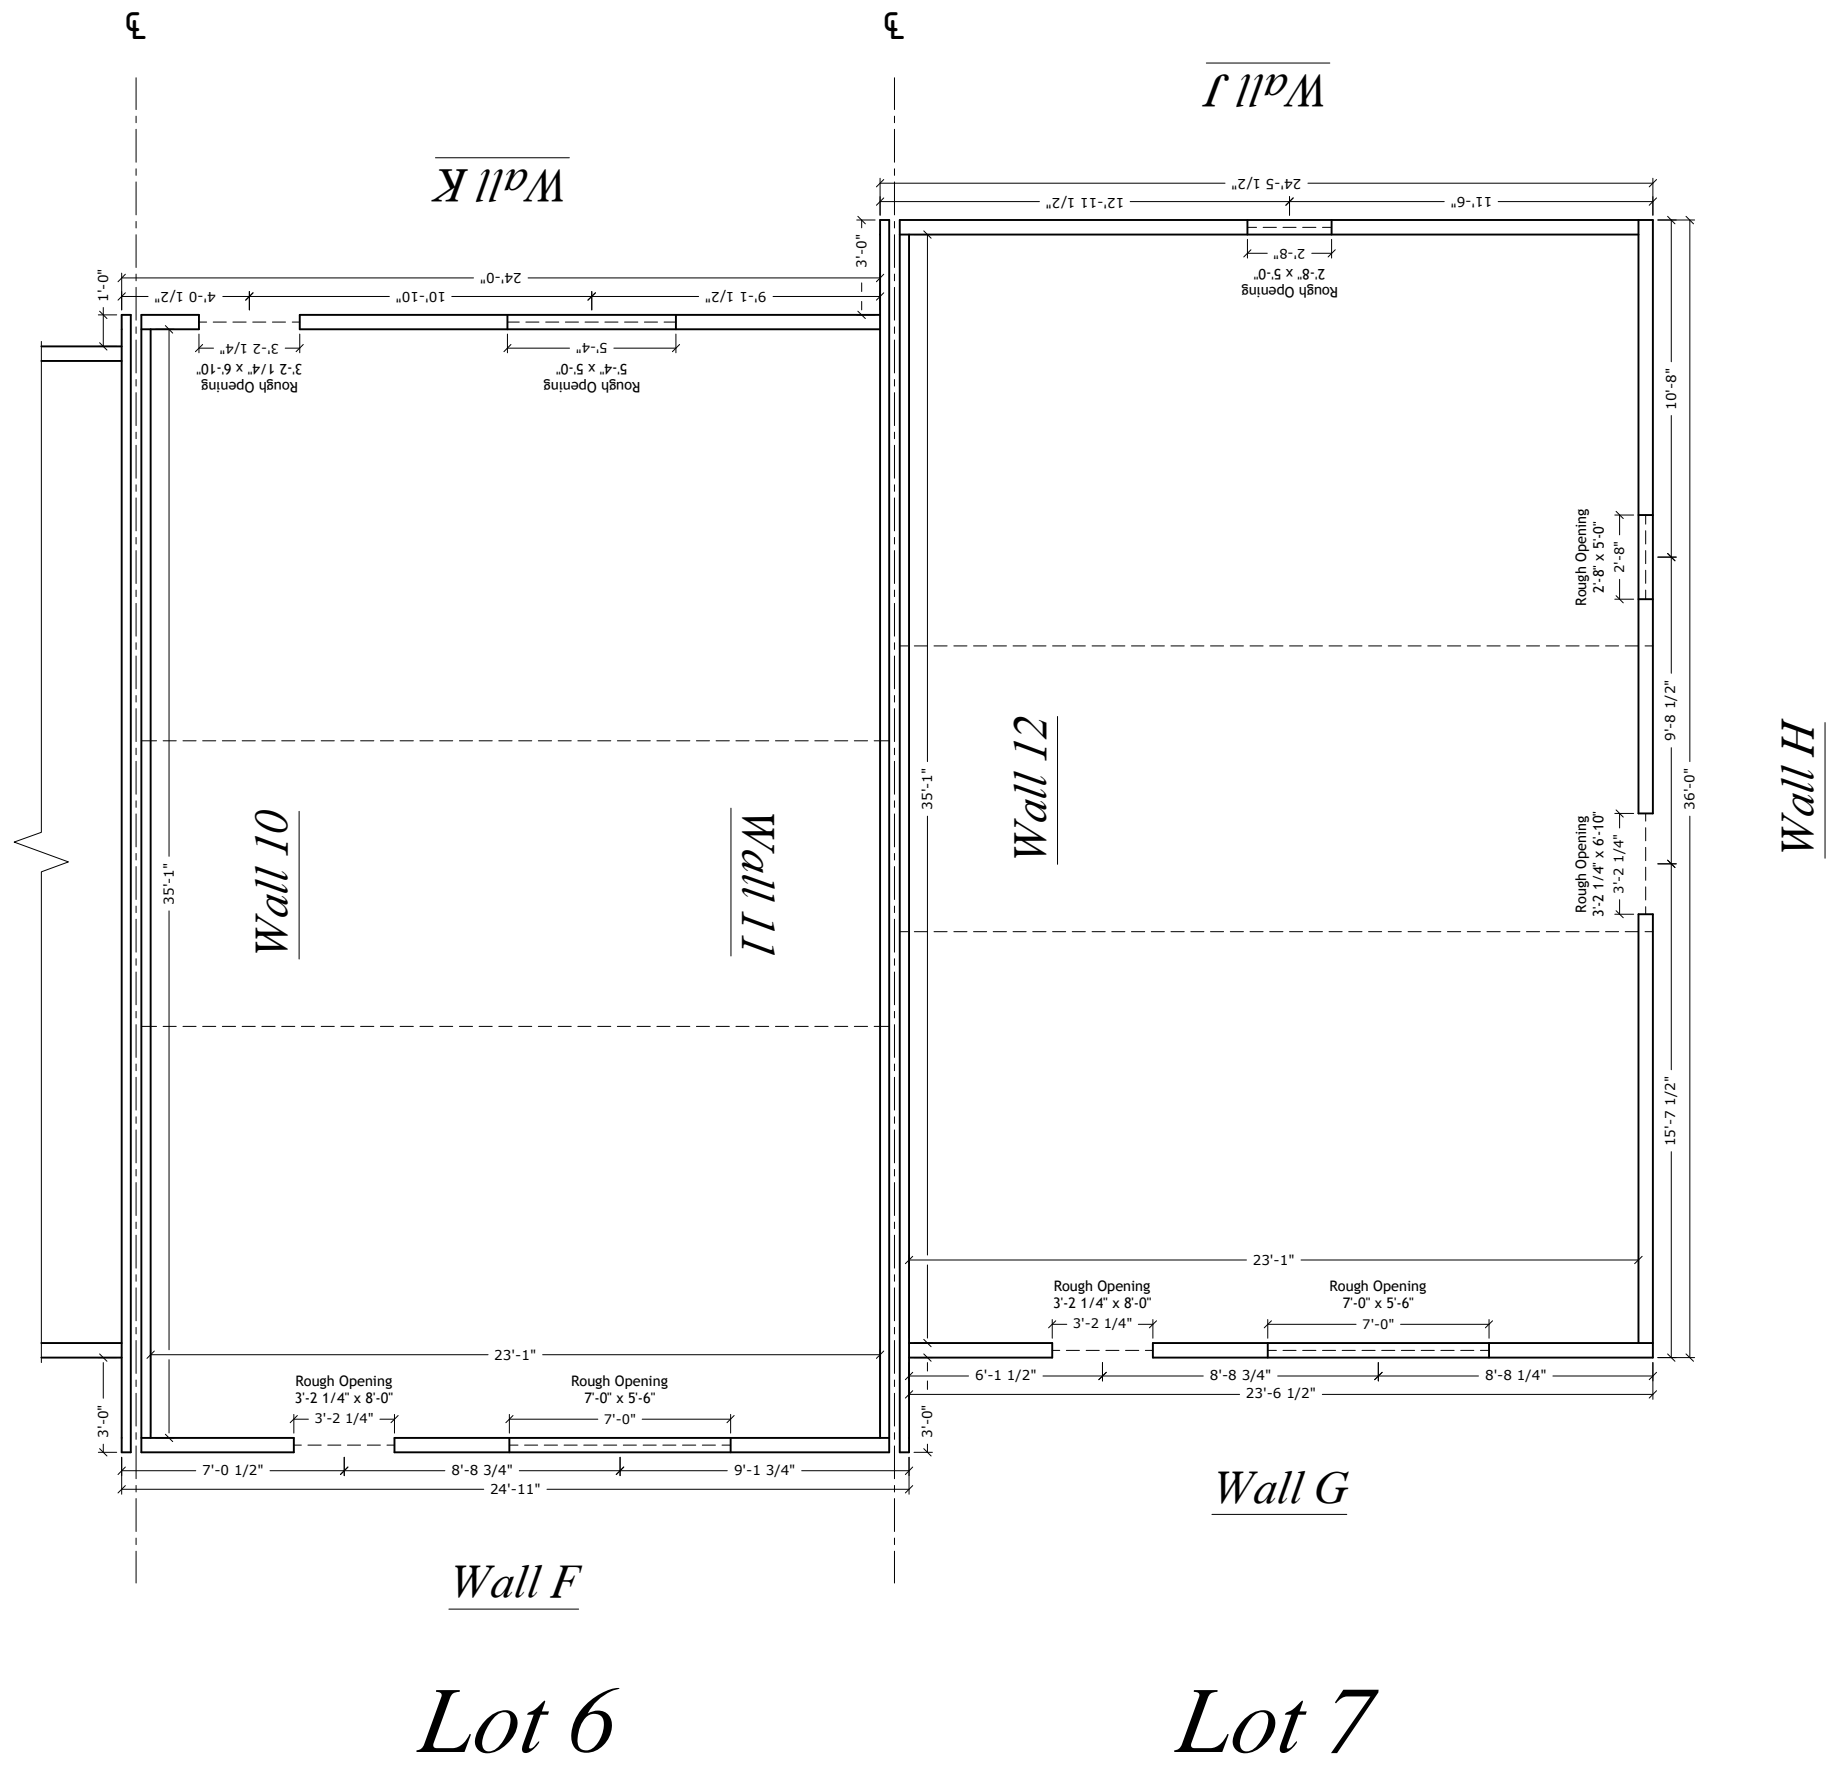


Newtown Road Townhomes (1st Floor Plan - Lots 6 & 7)

All engineering of the structure, including the ThermoSteel Building System specifications, is to be completed and/or approved by the Project Engineer and/or the Engineer of Record.
THERMASTEEL WALLFRAME SYSTEMS - MANUFACTURED BY THERMASTEEL Inc. - 609 WEST ROCK ROAD RADFORD, VA 24141 - PHONE (540) 633-5000, FAX (540) 633-5001 www.thermasteelinc.com
THE DRAWINGS HEREIN ARE PANEL MANUFACTURING DRAWINGS ONLY. CONTRACTOR SHALL BE SOLELY RESPONSIBLE FOR VERIFYING ALL DIMENSIONS, SITE CONDITIONS, AND THAT ALL STATE AND LOCAL CODE REQUIREMENTS ARE MET.

FINISH DATE:	5/12/2022
REVISION:	
SCALE:	NTS
DESIGNED:	
DRAWN:	PLiu

THERMASTEEL ADVANCED PANEL SYSTEMS
21-245C
JOB NUMBER

SHEET
FP-4

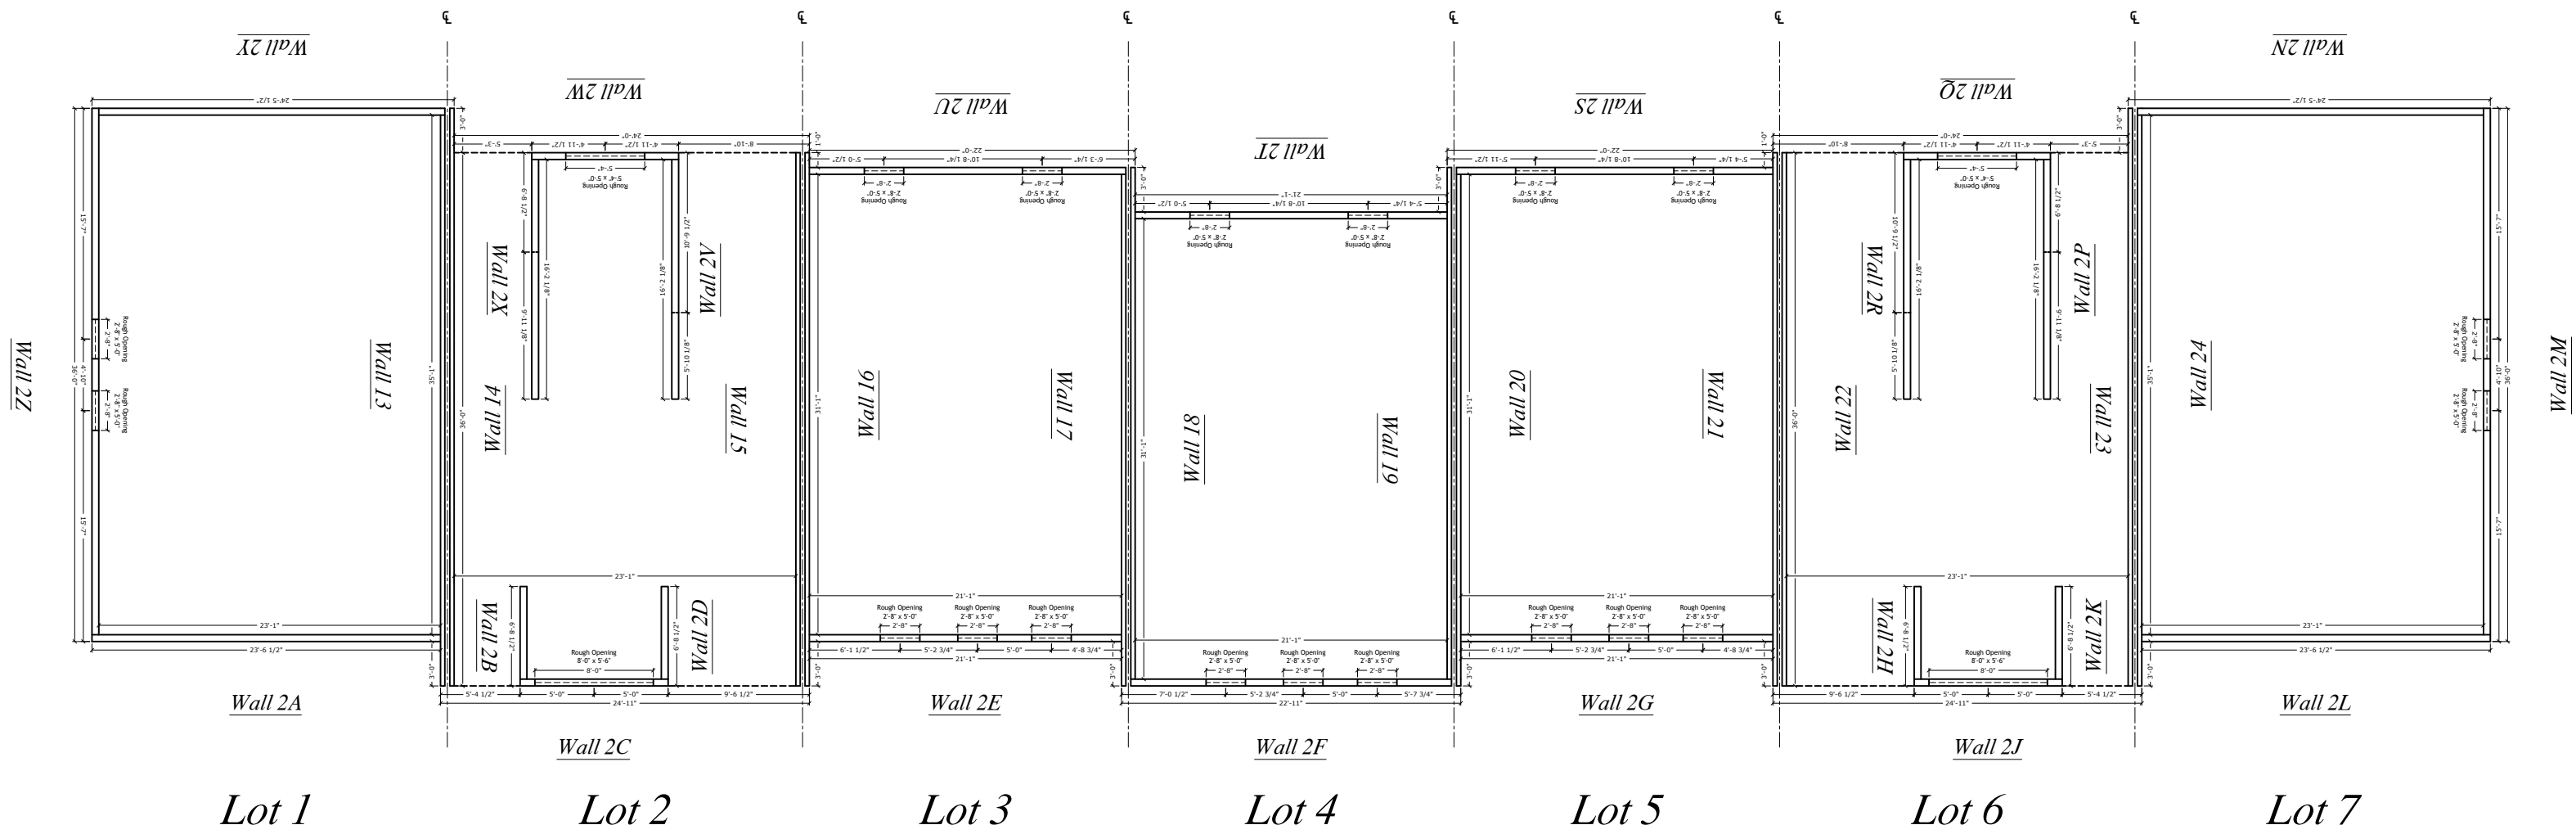


FINISH DATE:	5/12/2022
--------------	-----------



THERMASTEEL™
ADVANCED PANEL SYSTEMS


All engineering of the structure, including the ThermaSteel Building System specifications, is to be completed and/or approved by the Project Engineer and/or the Engineer of Record.

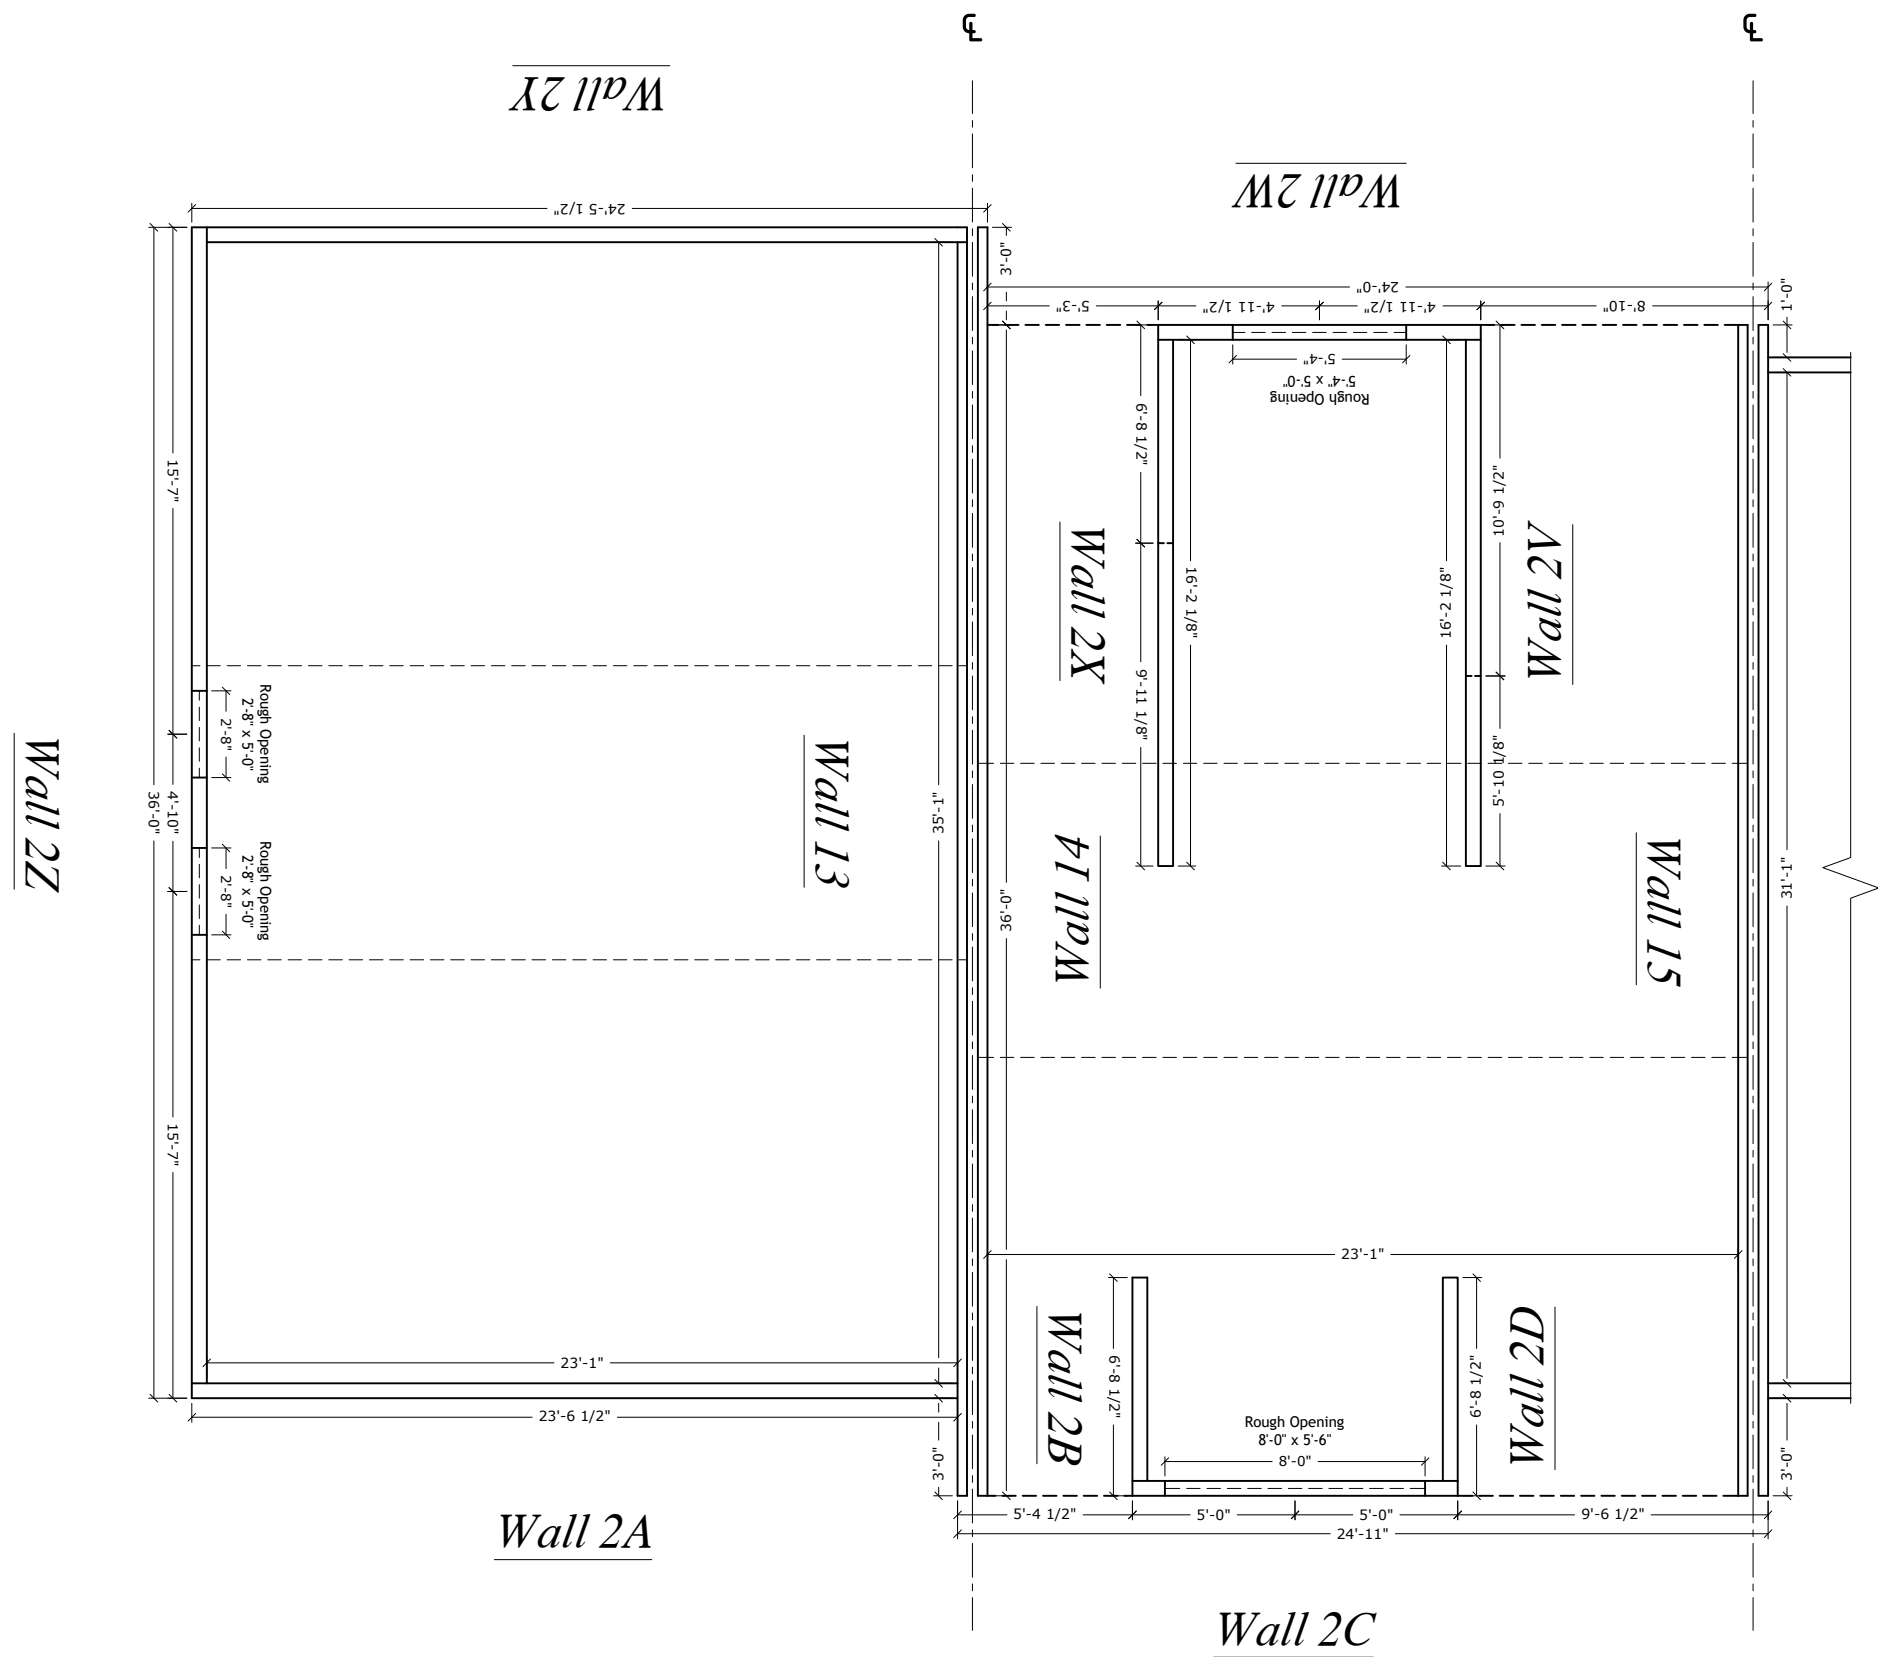

Newtown Road Townhomes (2nd Floor Plan - Lots 1 & 2)


All engineering of the structure, including the ThermoSteel Building System specifications, is to be completed and/or approved by the Project Engineer and/or the Engineer of Record.
THERMASTEEL WALLFRAME SYSTEMS - MANUFACTURED BY THERMASTEEL Inc. - 609 WEST ROCK ROAD RADFORD, VA 24141 - PHONE (540) 633-5000, FAX (540) 633-5001 www.thermasteelinc.com
THE DRAWINGS HEREIN ARE PANEL MANUFACTURING DRAWINGS ONLY. CONTRACTOR SHALL BE SOLELY RESPONSIBLE FOR VERIFYING ALL DIMENSIONS, SITE CONDITIONS, AND THAT ALL STATE AND LOCAL CODE REQUIREMENTS ARE MET.

FINISH DATE:	5/12/2022
REVISION:	
SCALE:	NTS
DESIGNED:	
DRAWN:	PLiu

**THERMASTEEL™**
ADVANCED PANEL SYSTEMS

21-245C
JOB NUMBER

SHEET
FP-6

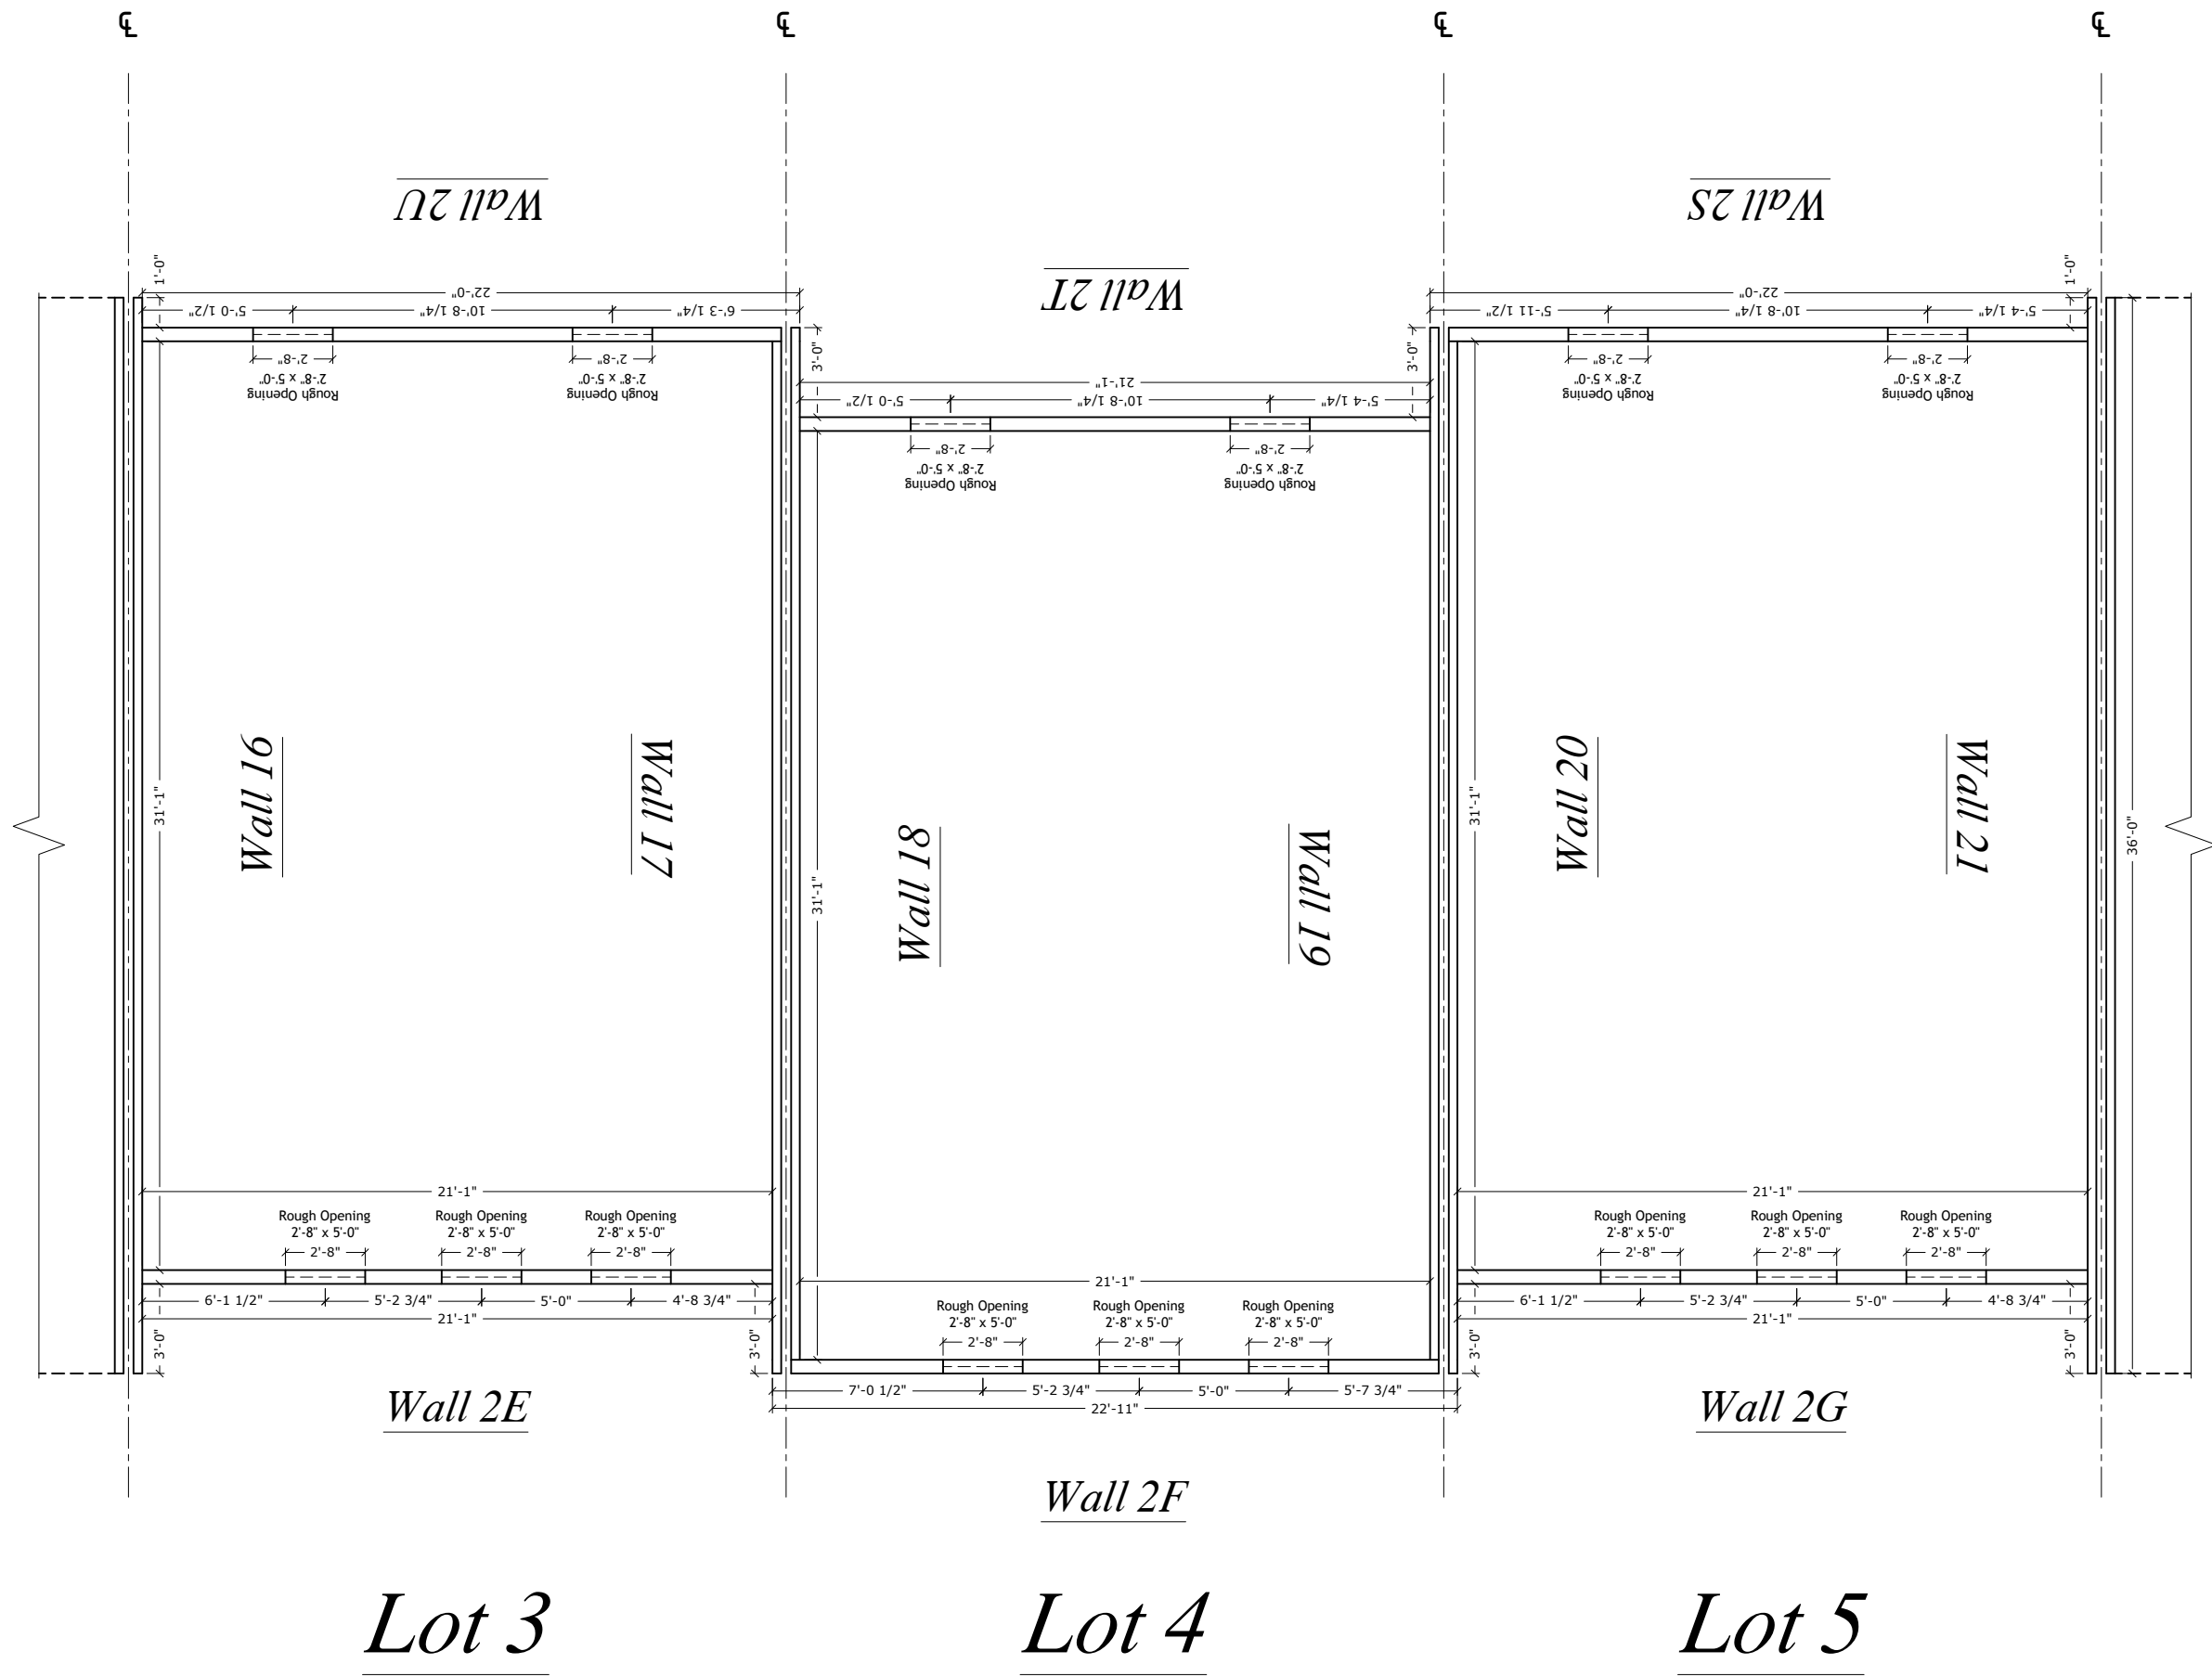

Newtown Road Townhomes (2nd Floor Plan - Lots 3 - 5)

All engineering of the structure, including the ThermaSteel Building System specifications, is to be completed and/or approved by the Project Engineer and/or the Engineer of Record.
THERMASTEEL WALLFRAME SYSTEMS - MANUFACTURED BY THERMASTEEL Inc. - 609 WEST ROCK ROAD RADFORD, VA 24141 - PHONE (540) 633-5000, FAX (540) 633-5001 www.thermasteelinc.com
THE DRAWINGS HEREIN ARE PANEL MANUFACTURING DRAWINGS ONLY. CONTRACTOR SHALL BE SOLELY RESPONSIBLE FOR VERIFYING ALL DIMENSIONS, SITE CONDITIONS, AND THAT ALL STATE AND LOCAL CODE REQUIREMENTS ARE MET.


FINISH DATE:	5/12/2022
REVISION:	
SCALE:	NTS
DESIGNED:	
DRAWN:	PLiu

THERMASTEEL
ADVANCED PANEL SYSTEMS

21-245C

JOB NUMBER

SHEET
FP-7

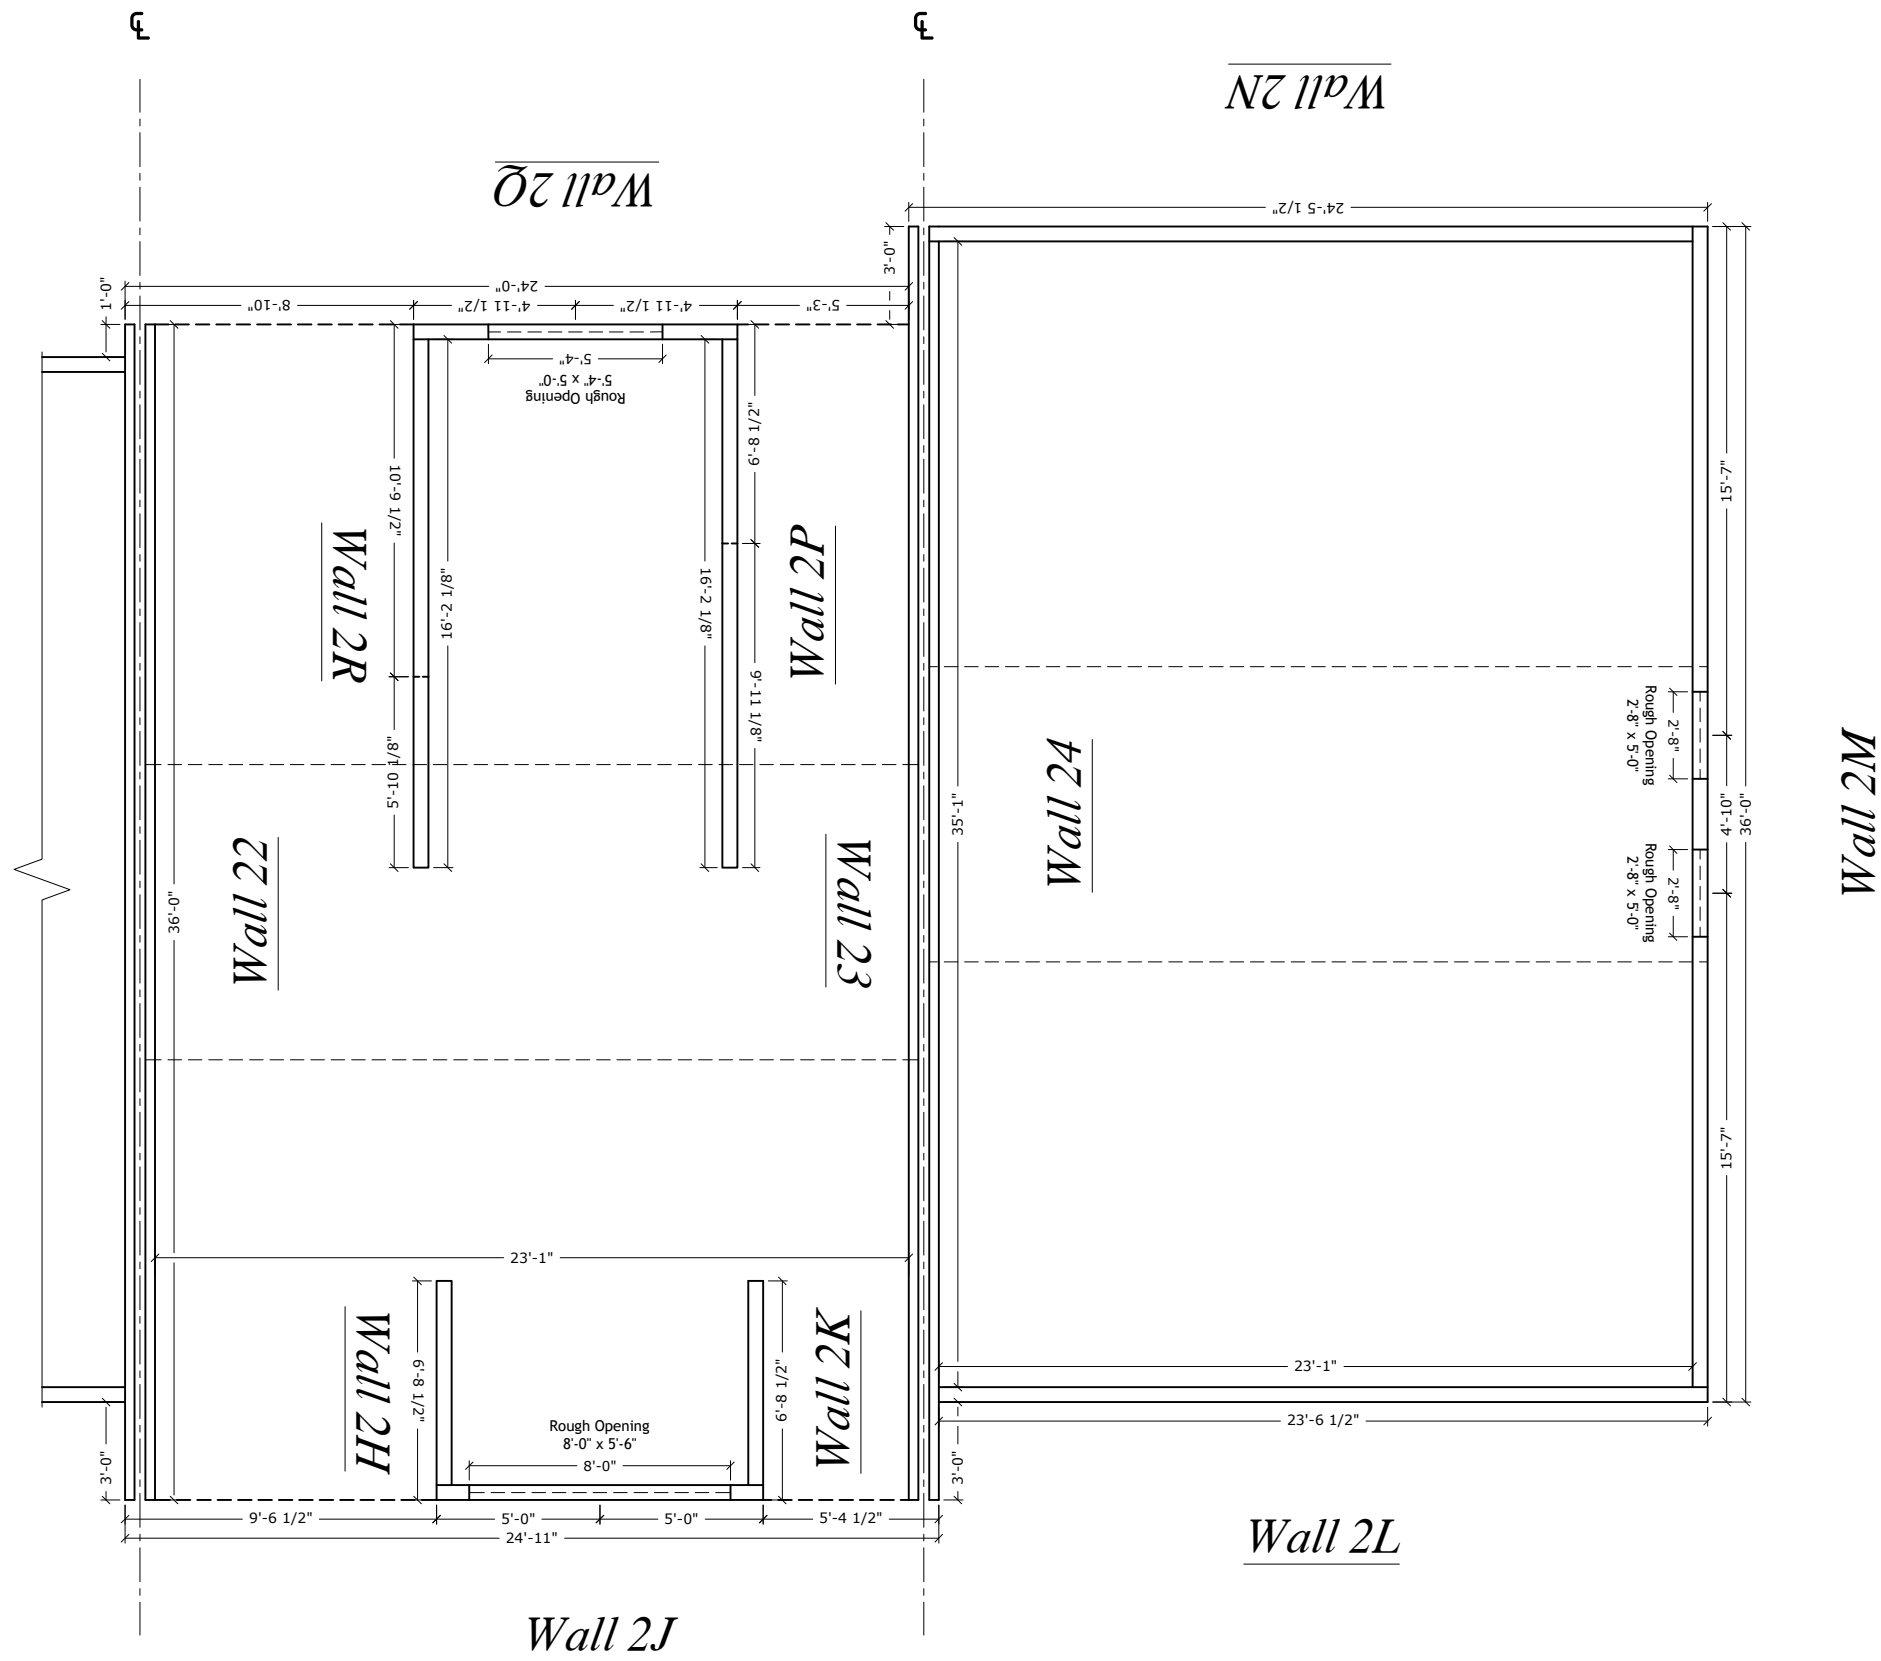

Lot 6

Lot 7

Newtown Road Townhomes (2nd Floor Plan - Lots 6 - 7)


All engineering of the structure, including the ThermaSteel Building System specifications, is to be completed and/or approved by the Project Engineer and/or the Engineer of Record.
THERMASTEEL WALLFRAME SYSTEMS - MANUFACTURED BY THERMASTEEL Inc. - 609 WEST ROCK ROAD RADFORD, VA 24141 - PHONE (540) 633-5000, FAX (540) 633-5001 www.thermasteelinc.com
THE DRAWINGS HEREIN ARE PANEL MANUFACTURING DRAWINGS ONLY. CONTRACTOR SHALL BE SOLELY RESPONSIBLE FOR VERIFYING ALL DIMENSIONS, SITE CONDITIONS, AND THAT ALL STATE AND LOCAL CODE REQUIREMENTS ARE MET.

FINISH DATE:	5/12/2022
REVISION:	
SCALE:	NTS
DESIGNED:	
DRAWN:	PLiu

**THERMASTEEL™**
ADVANCED PANEL SYSTEMS

21-245C
JOB NUMBER

SHEET
FP-8

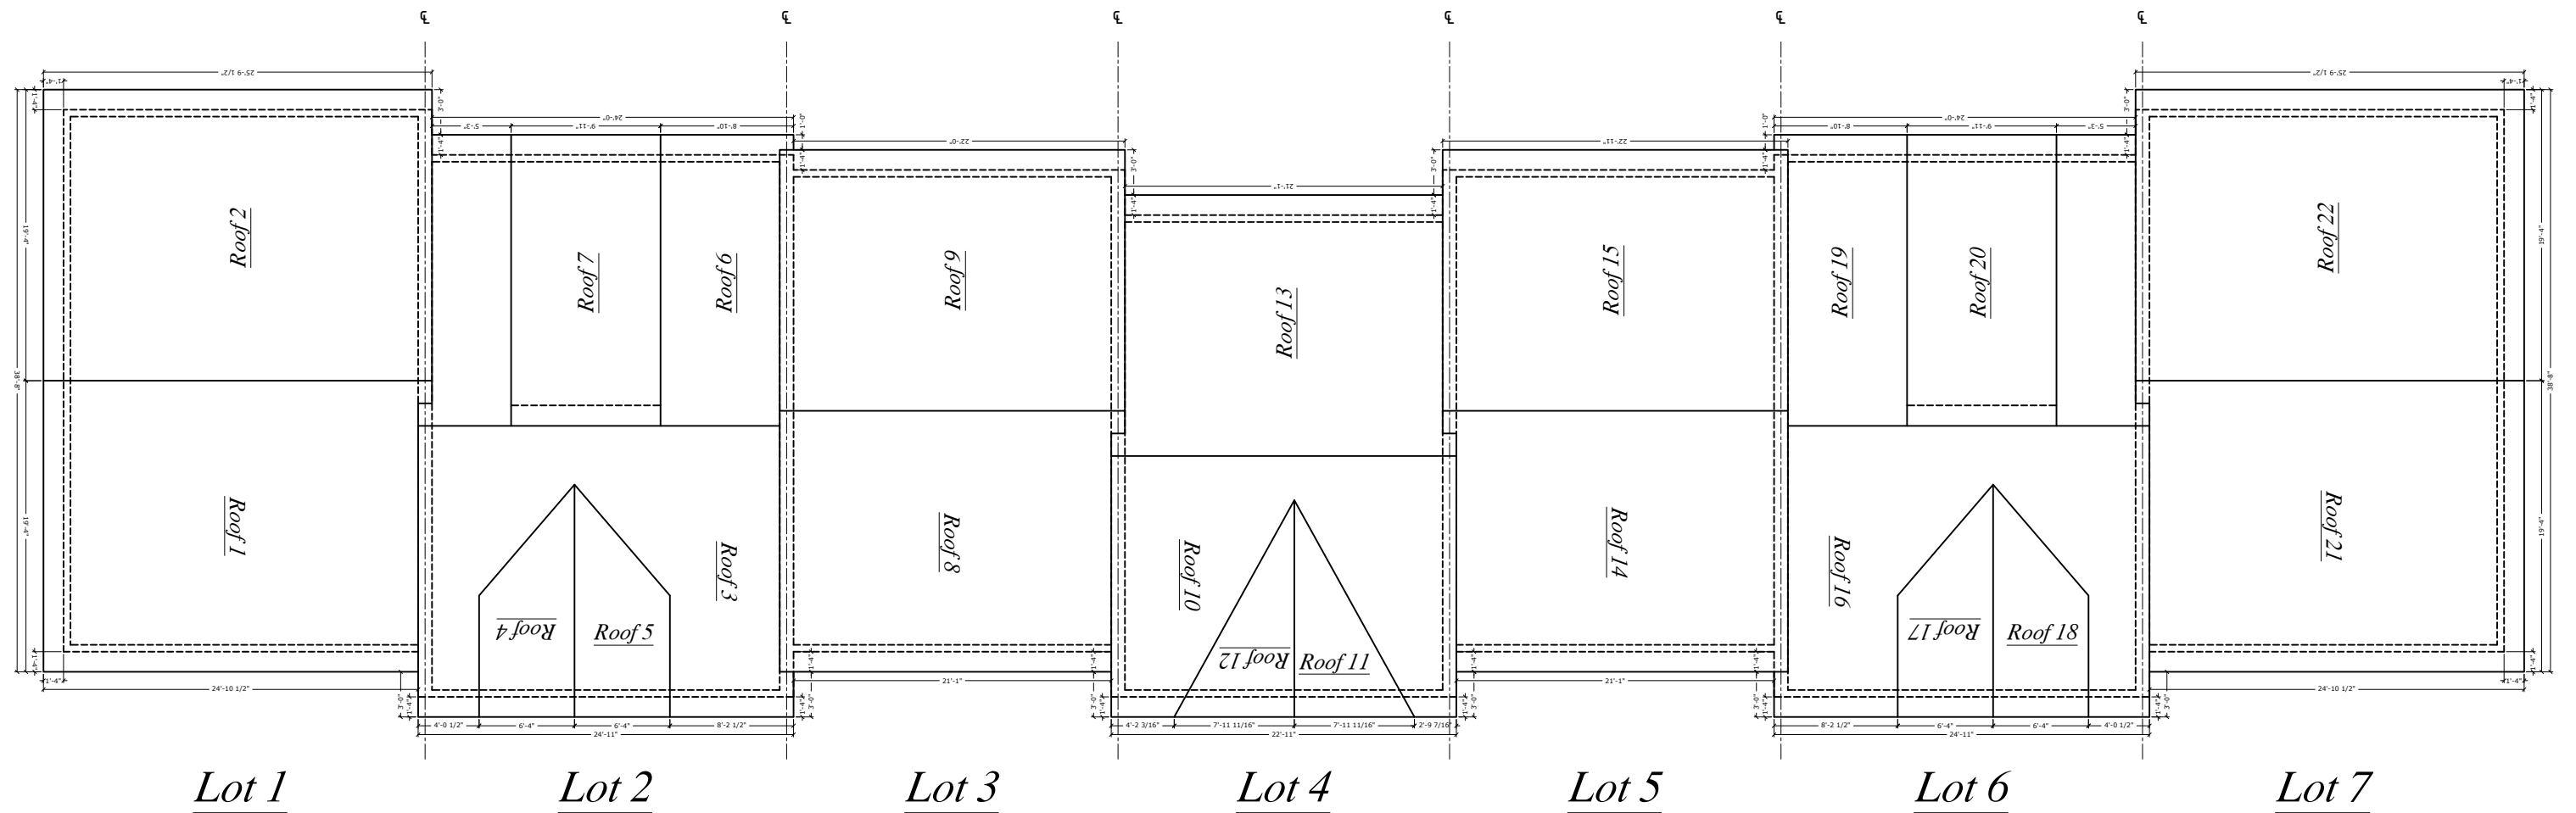

Newtown Road Townhomes (Roof Plan - Lots 1 - 7)


All engineering of the structure, including the ThermaSteel Building System specifications, is to be completed and/or approved by the Project Engineer and/or the Engineer of Record.
THERMASTEEL WALLFRAME SYSTEMS - MANUFACTURED BY THERMASTEEL Inc. - 609 WEST ROCK ROAD RADFORD, VA 24141 - PHONE (540) 633-5000, FAX (540) 633-5001 www.thermasteelinc.com
THE DRAWINGS HEREIN ARE PANEL MANUFACTURING DRAWINGS ONLY. CONTRACTOR SHALL BE SOLELY RESPONSIBLE FOR VERIFYING ALL DIMENSIONS, SITE CONDITIONS, AND THAT ALL STATE AND LOCAL CODE REQUIREMENTS ARE MET.

FINISH DATE:	5/12/2022
REVISION:	
SCALE:	NTS
DESIGNED:	
DRAWN:	PLiu

**THERMASTEEL**
ADVANCED PANEL SYSTEMS

21-245C
JOB NUMBER

SHEET
RP-1

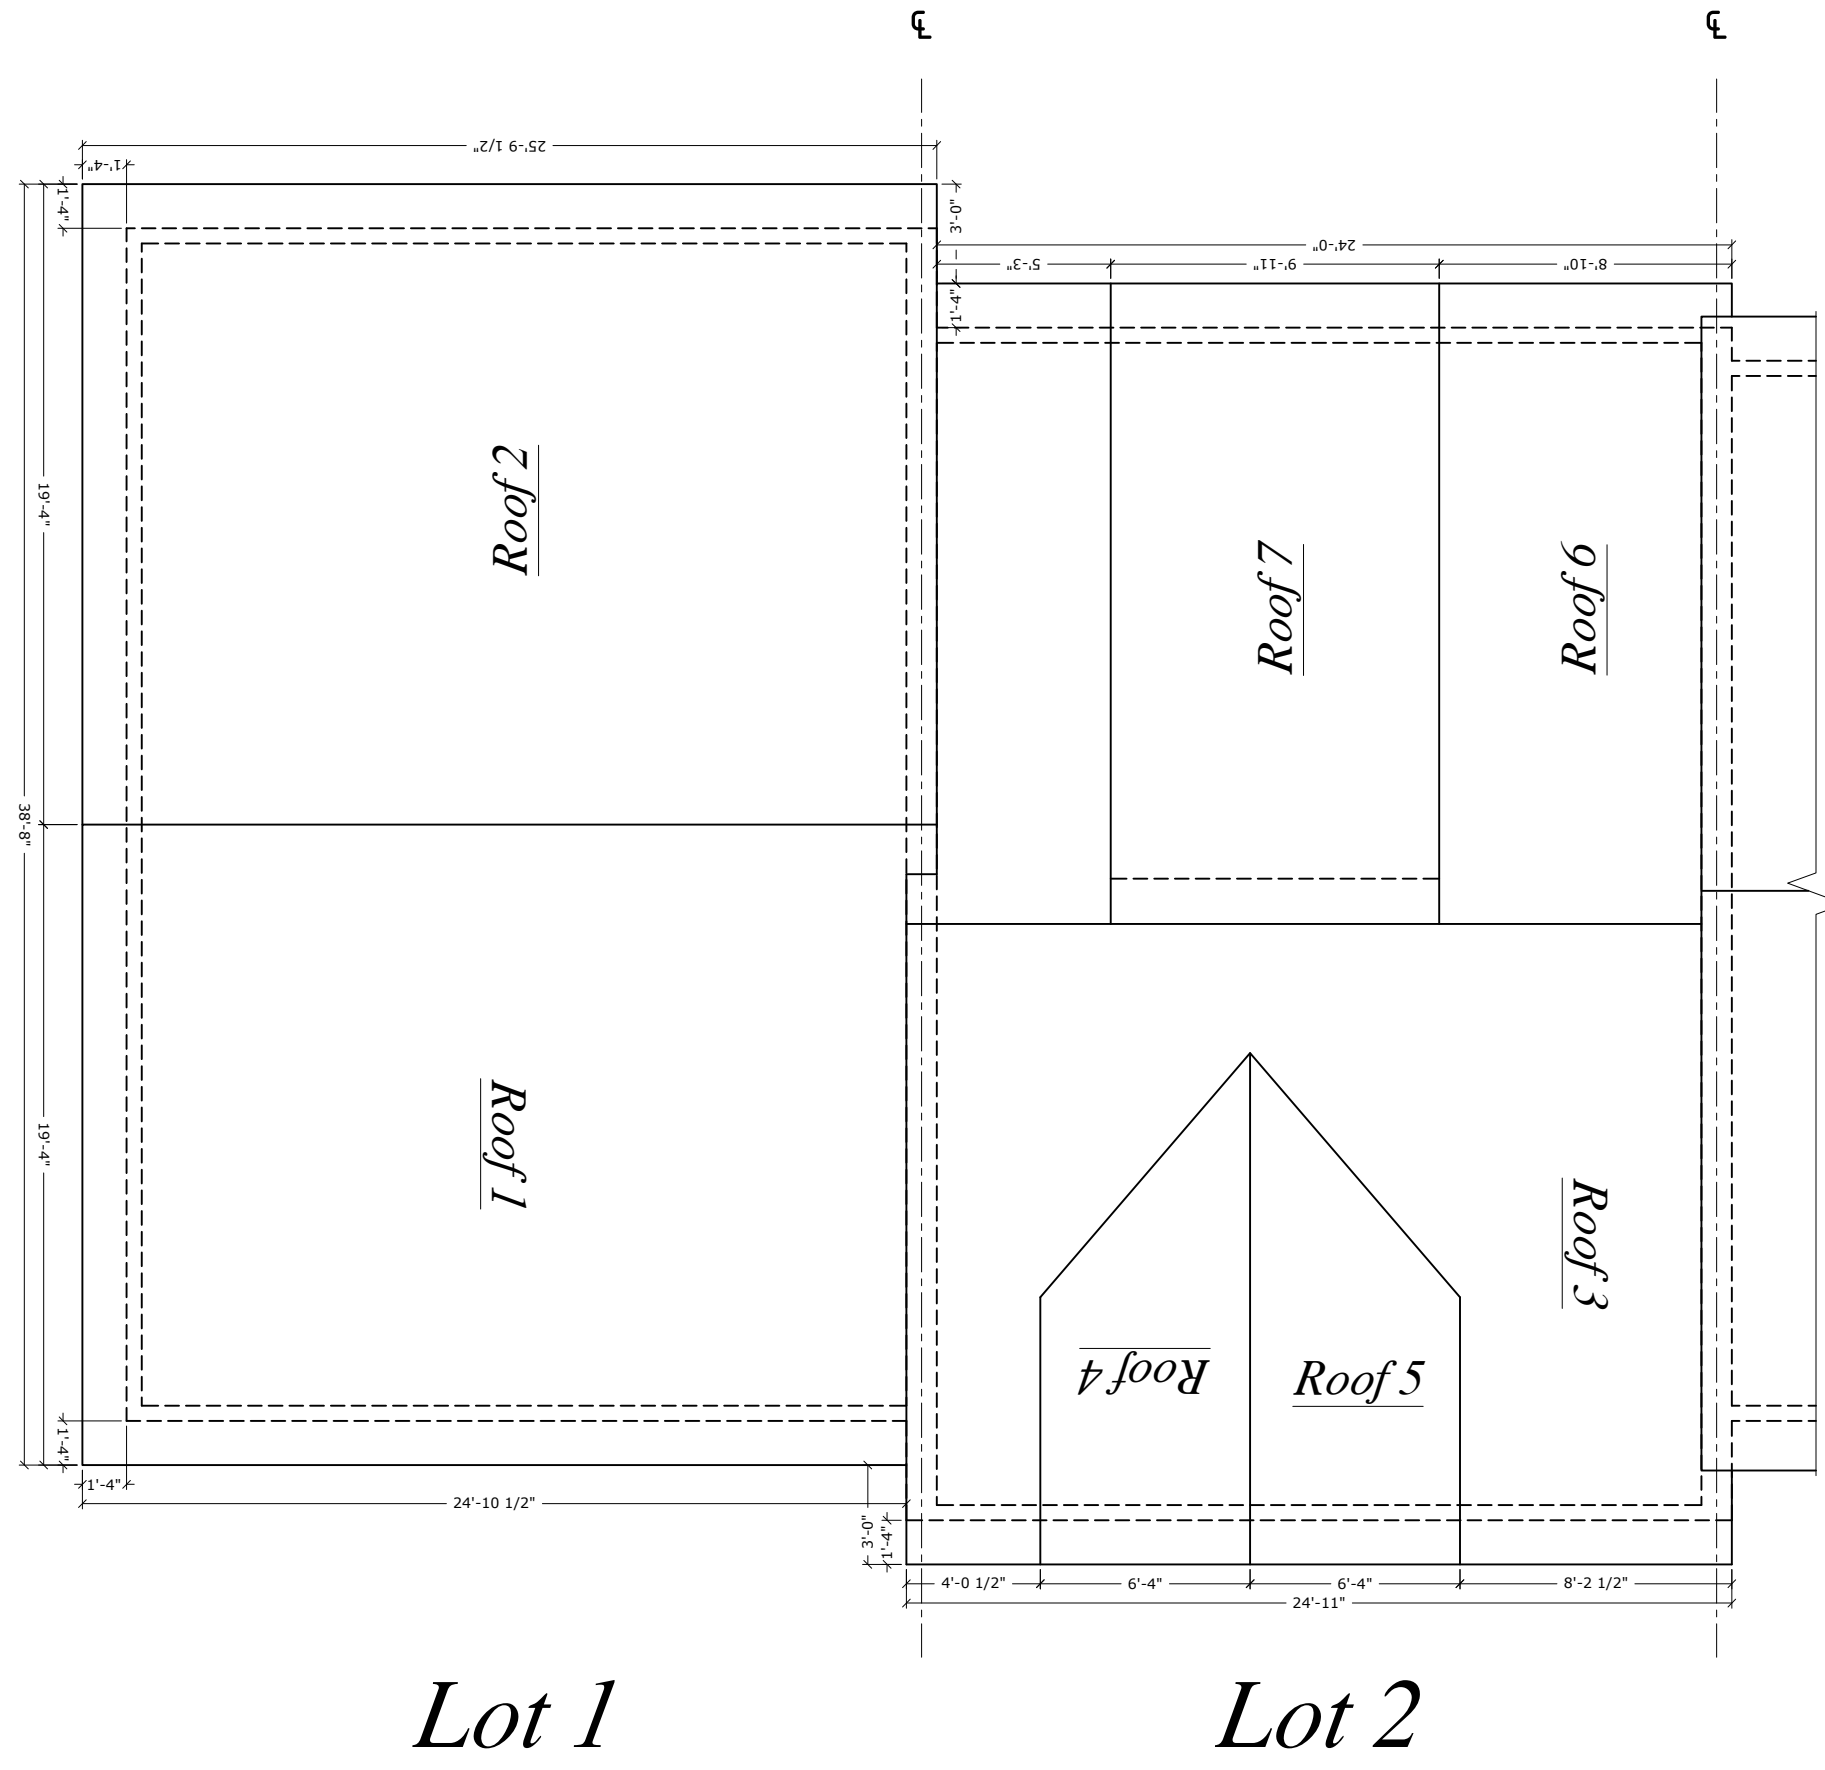

Newtown Road Townhomes (Roof Plan - Lots 1 & 2)

All engineering of the structure, including the ThermoSteel Building System specifications, is to be completed and/or approved by the Project Engineer and/or the Engineer of Record.
THERMASTEEL WALLFRAME SYSTEMS - MANUFACTURED BY THERMASTEEL Inc. - 609 WEST ROCK ROAD RADFORD, VA 24141 - PHONE (540) 633-5000, FAX (540) 633-5001 www.thermasteelinc.com
THE DRAWINGS HEREIN ARE PANEL MANUFACTURING DRAWINGS ONLY. CONTRACTOR SHALL BE SOLELY RESPONSIBLE FOR VERIFYING ALL DIMENSIONS, SITE CONDITIONS, AND THAT ALL STATE AND LOCAL CODE REQUIREMENTS ARE MET.

FINISH DATE:	5/12/2022
REVISION:	
SCALE:	NTS
DESIGNED:	
DRAWN:	PLiu

THERMASTEEL
ADVANCED PANEL SYSTEMS

21-245C


JOB NUMBER

SHEET
RP-2



RP-3

THE DRAWINGS HEREIN ARE PANEL MANUFACTURING DRAWINGS ONLY. CONTRACTOR SHALL BE SOLELY RESPONSIBLE FOR VERIFYING ALL DIMENSIONS, SITE CONDITIONS, AND THAT ALL STATE AND LOCAL CODE REQUIREMENTS ARE MET.

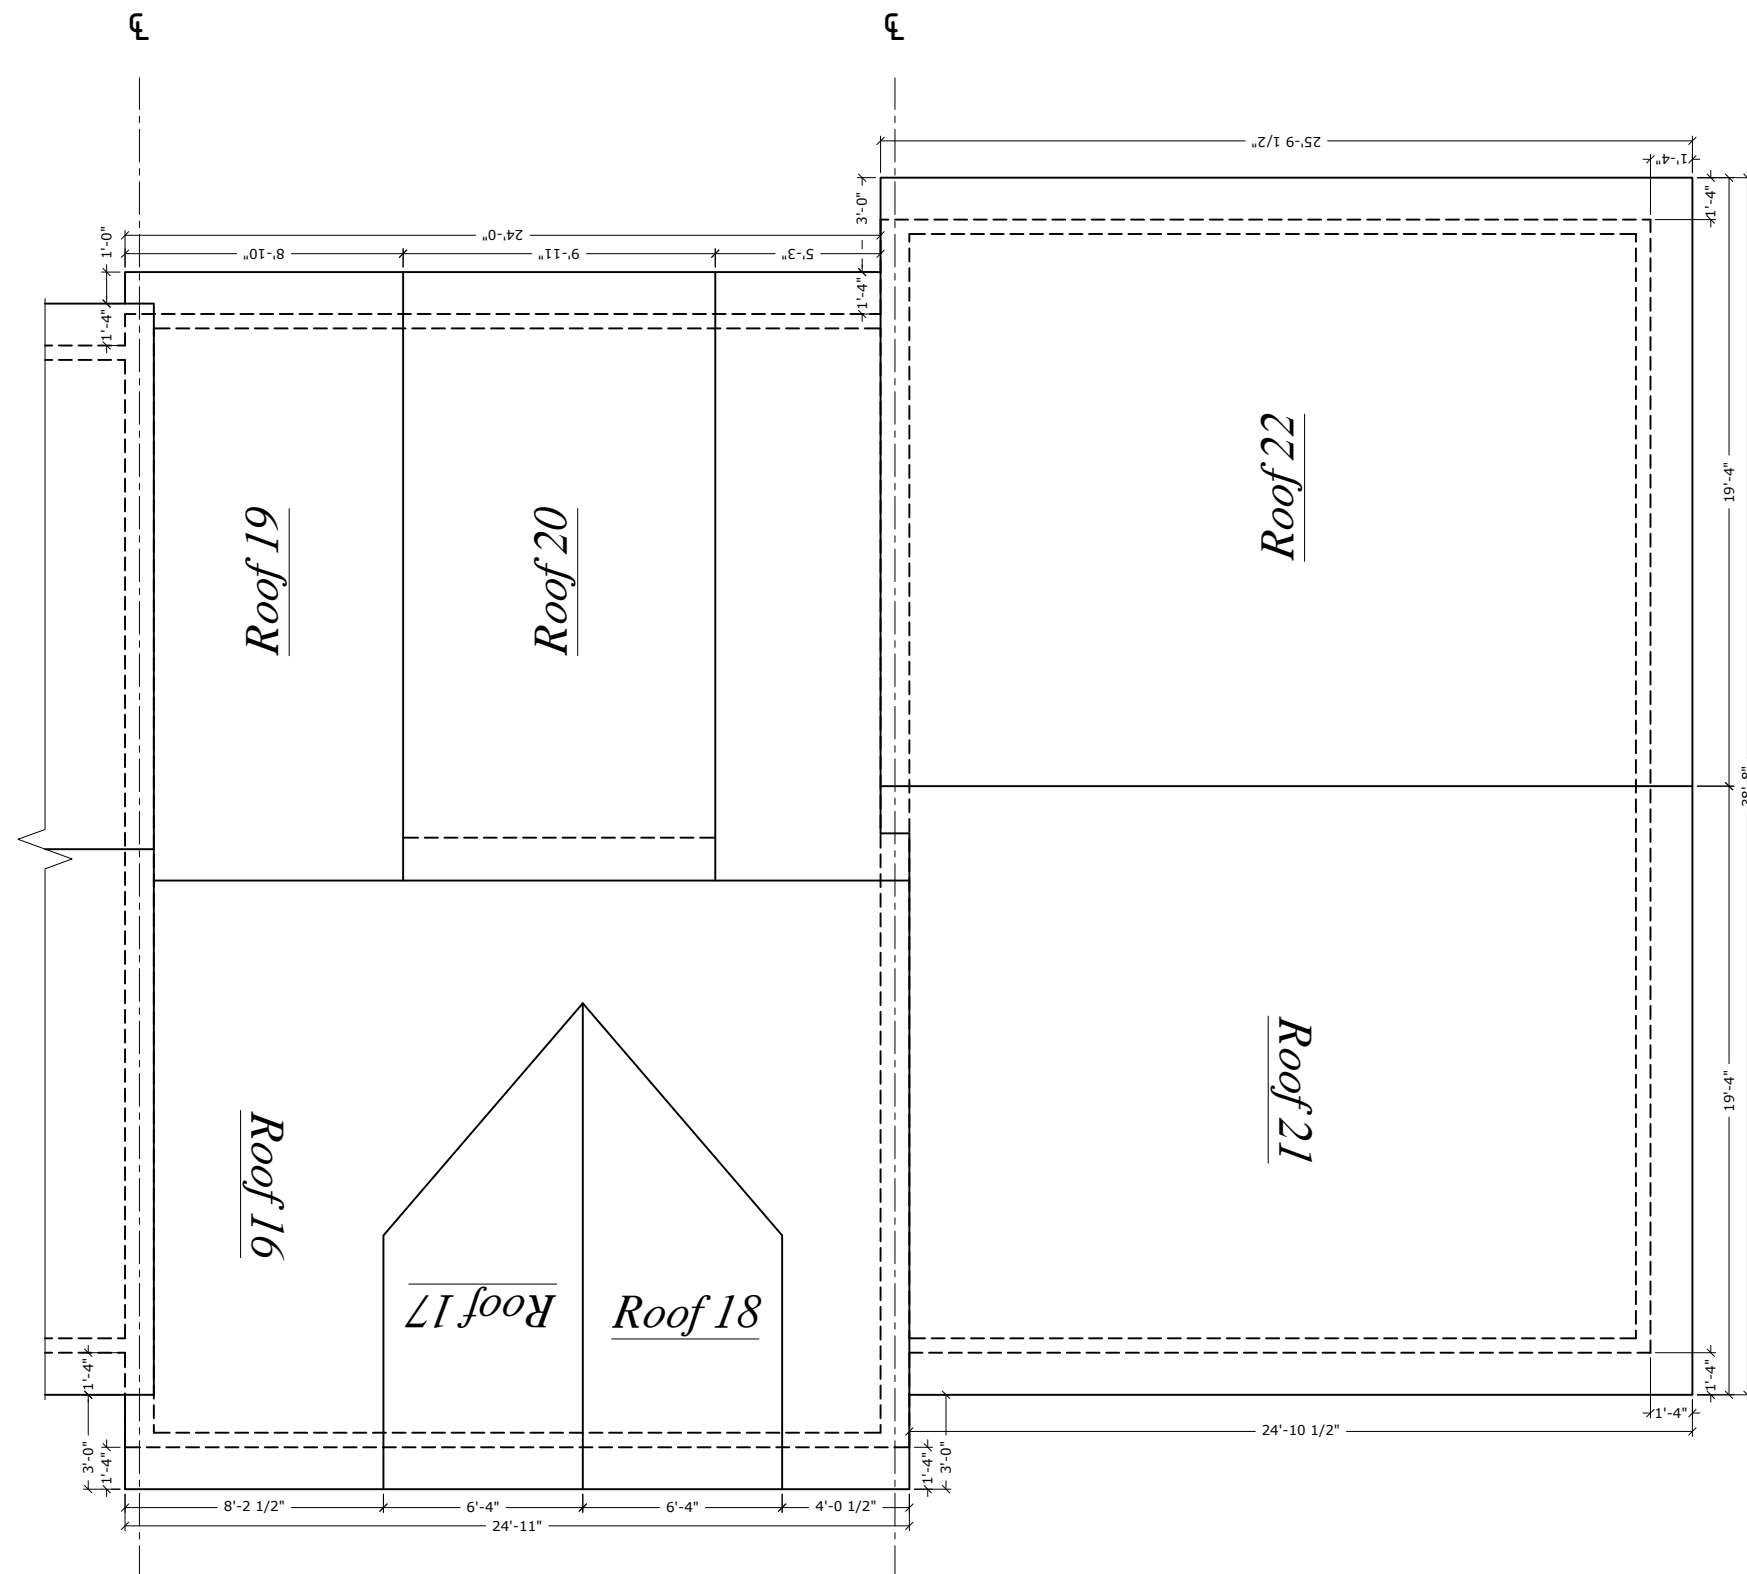

Lot 6

Lot 7

Newtown Road Townhomes (Roof Plan - Lots 6 & 7)


All engineering of the structure, Including the ThermaSteel Building System specifications, is to be completed and/or approved by the Project Engineer and/or the Engineer of Record.
THERMASTEEL WALLFRAME SYSTEMS - MANUFACTURED BY THERMASTEEL Inc. - 609 WEST ROCK ROAD RADFORD, VA 24141 - PHONE (540) 633-5000, FAX (540) 633-5001 www.thermasteelinc.com
THE DRAWINGS HEREIN ARE PANEL MANUFACTURING DRAWINGS ONLY. CONTRACTOR SHALL BE SOLELY RESPONSIBLE FOR VERIFYING ALL DIMENSIONS, SITE CONDITIONS, AND THAT ALL STATE AND LOCAL CODE REQUIREMENTS ARE MET.

FINISH DATE:	5/12/2022
REVISION:	
SCALE:	NTS
DESIGNED:	
DRAWN:	PLiu


**THERMASTEEL™**
ADVANCED PANEL SYSTEMS

21-245C
JOB NUMBER

SHEET
RP-4

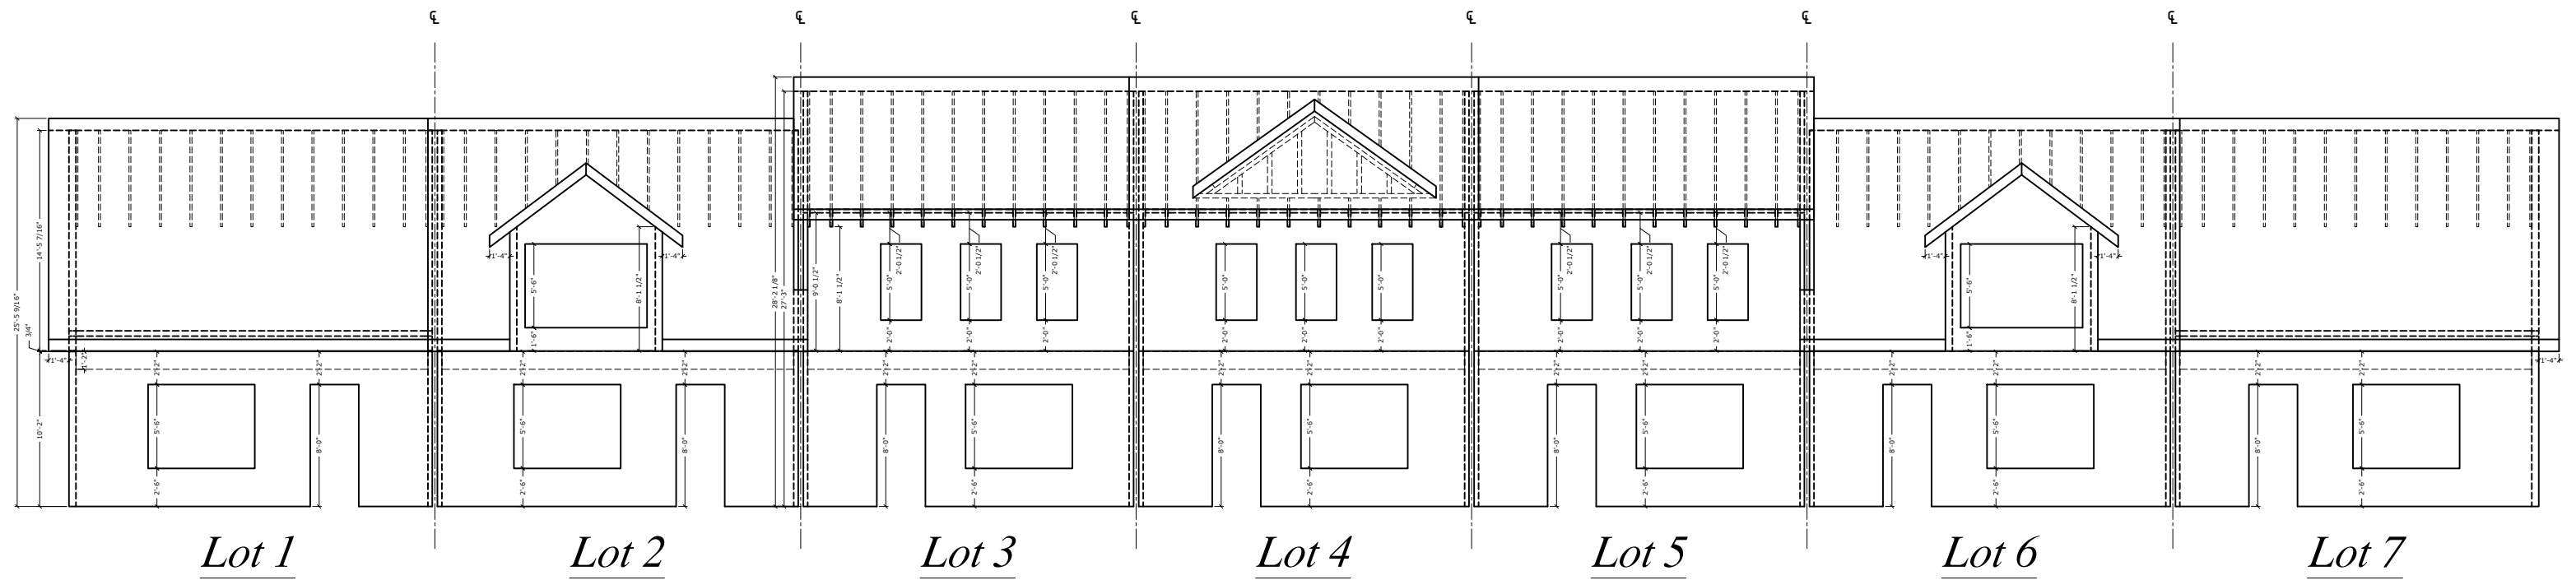

Front Elevation

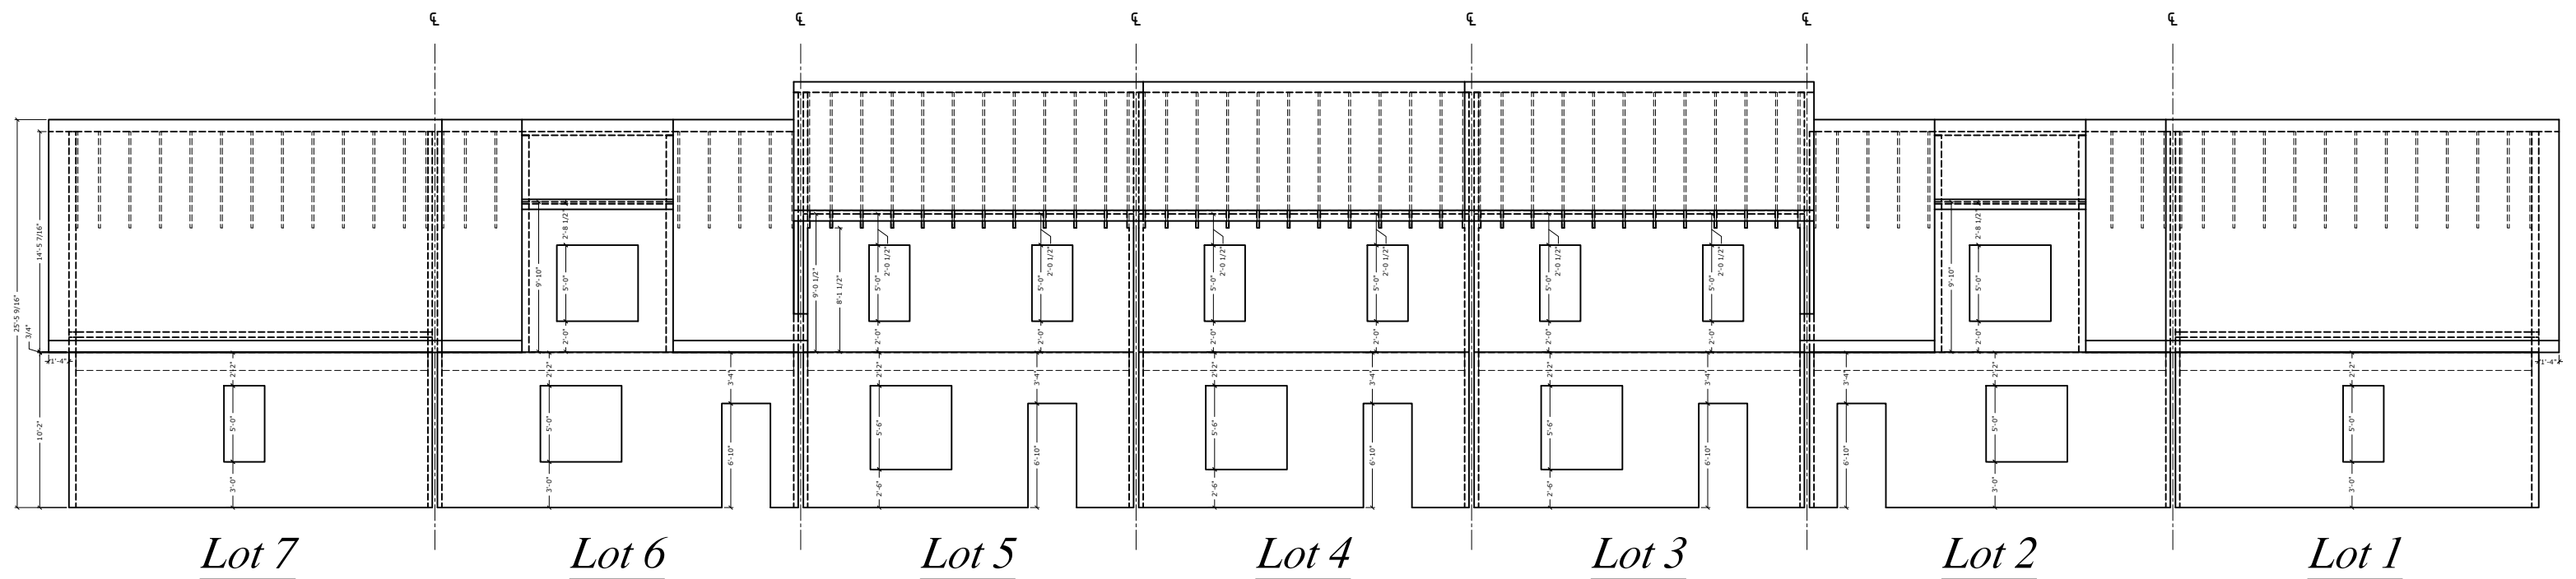

Rear Elevation

Newtown Road Townhomes (Elevations)

All engineering of the structure, including the ThermoSteel Building System specifications, is to be completed and/or approved by the Project Engineer and/or the Engineer of Record.
THERMASTEEL WALLFRAME SYSTEMS - MANUFACTURED BY THERMASTEEL Inc. - 609 WEST ROCK ROAD RADFORD, VA 24141 - PHONE (540) 633-5000, FAX (540) 633-5001 www.thermasteelinc.com
THE DRAWINGS HEREIN ARE PANEL MANUFACTURING DRAWINGS ONLY. CONTRACTOR SHALL BE SOLELY RESPONSIBLE FOR VERIFYING ALL DIMENSIONS, SITE CONDITIONS, AND THAT ALL STATE AND LOCAL CODE REQUIREMENTS ARE MET.


FINISH DATE:	5/12/2022
REVISION:	
SCALE:	NTS
DESIGNED:	
DRAWN:	PLiu


THERMASTEEL
ADVANCED PANEL SYSTEMS


21-245C
JOB NUMBER

SHEET

EV-1

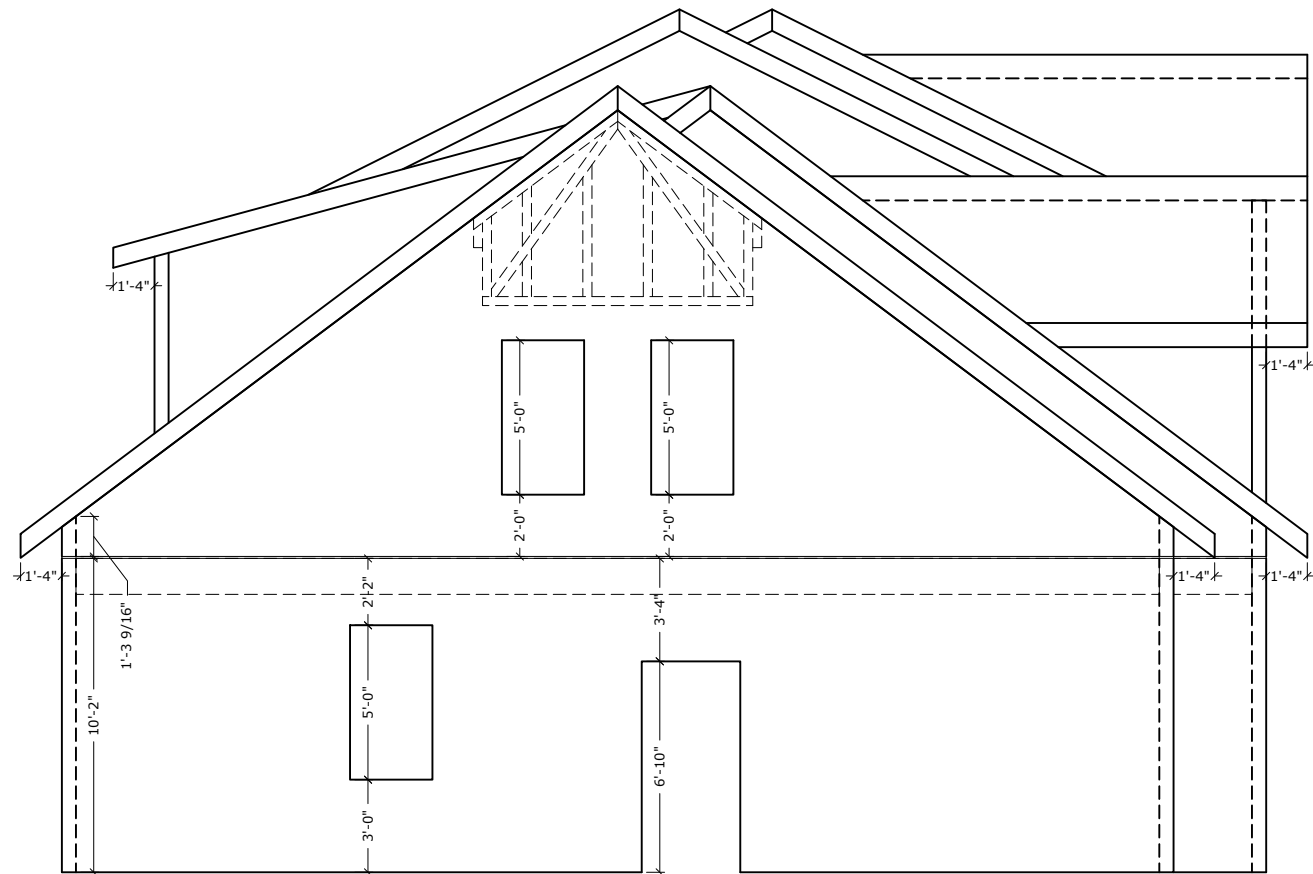

Left Side Elevation

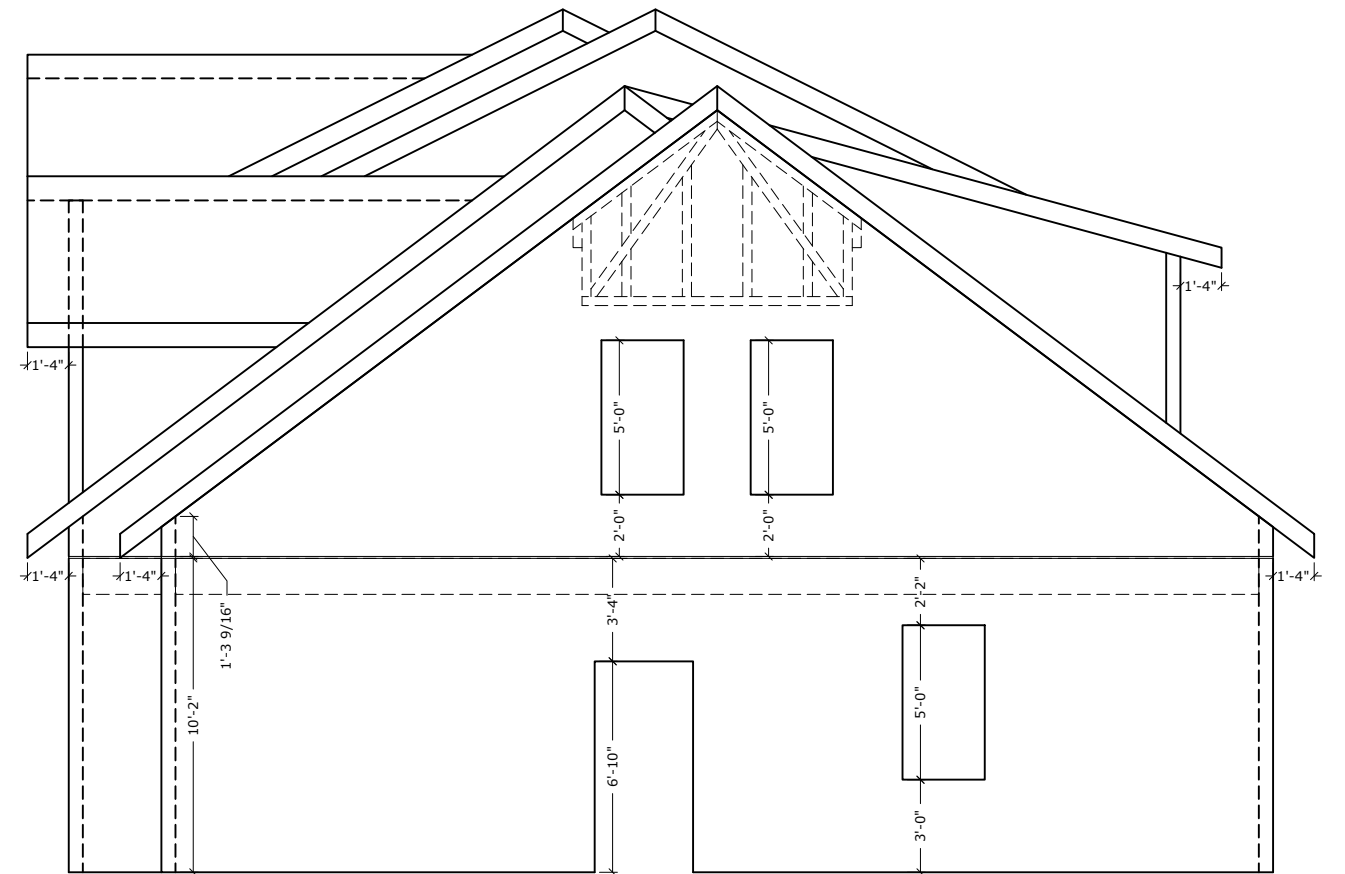

Right Side Elevation

Newtown Road Townhomes (Elevations)










All engineering of the structure, including the ThermoSteel Building System specifications, is to be completed and/or approved by the Project Engineer and/or the Engineer of Record.
THERMASTEEL WALLFRAME SYSTEMS - MANUFACTURED BY THERMASTEEL Inc. - 609 WEST ROCK ROAD RADFORD, VA 24141 - PHONE (540) 633-5000, FAX (540) 633-5001 www.thermasteelinc.com
THE DRAWINGS HEREIN ARE PANEL MANUFACTURING DRAWINGS ONLY. CONTRACTOR SHALL BE SOLELY RESPONSIBLE FOR VERIFYING ALL DIMENSIONS, SITE CONDITIONS, AND THAT ALL STATE AND LOCAL CODE REQUIREMENTS ARE MET.



FINISH DATE: 5/12/2022
REVISION:
SCALE: NTS
DESIGNED:
DRAWN: PLiu

THERMASTEEL
ADVANCED PANEL SYSTEMS
21-245C
JOB NUMBER

SHEET

EV-2

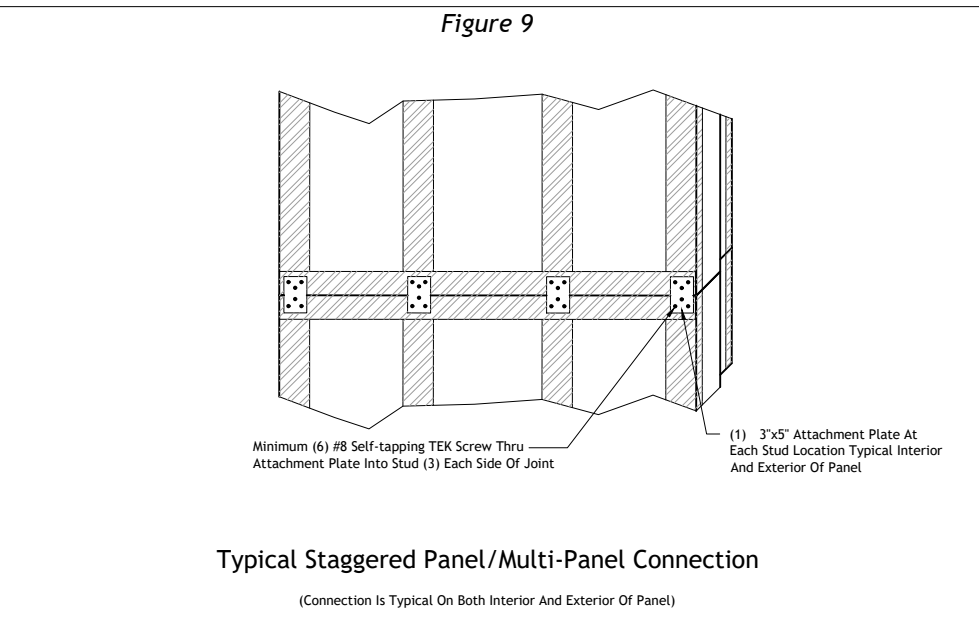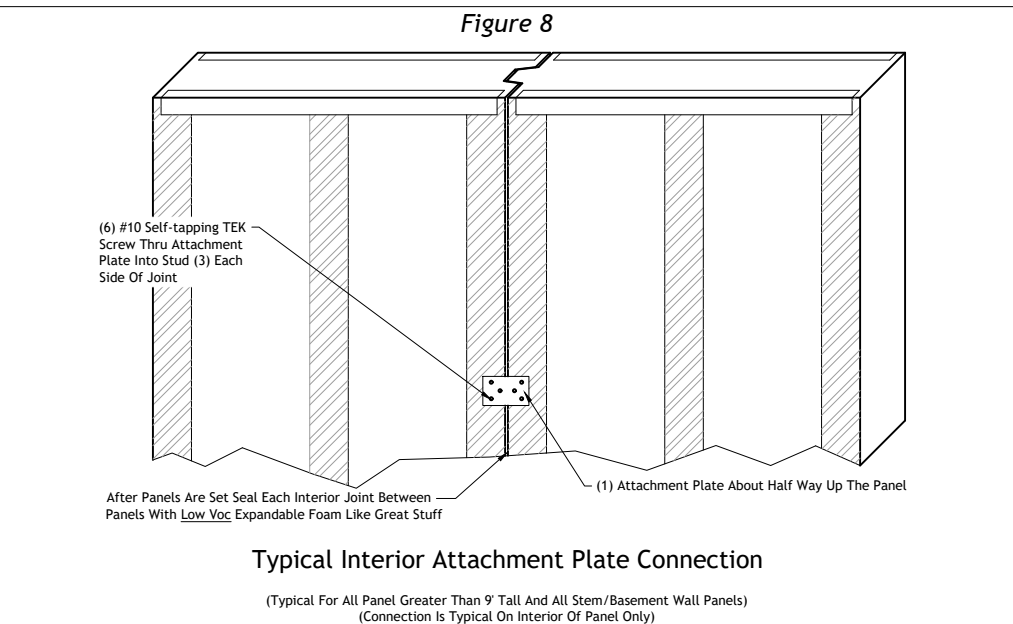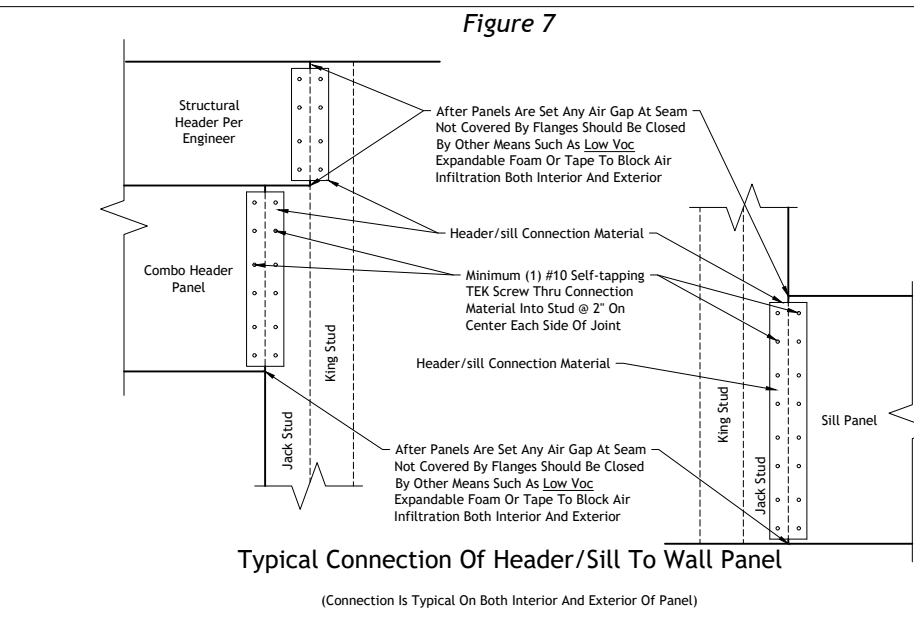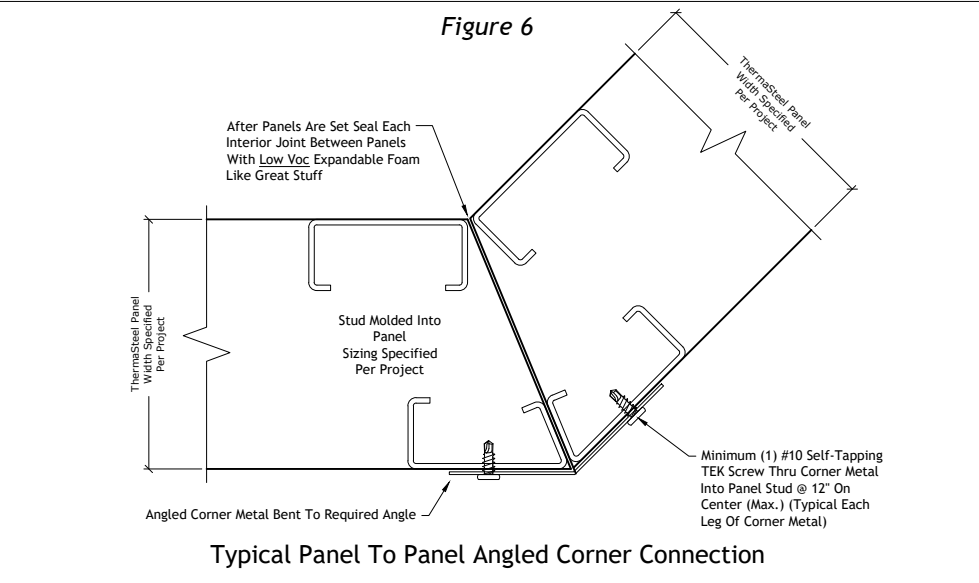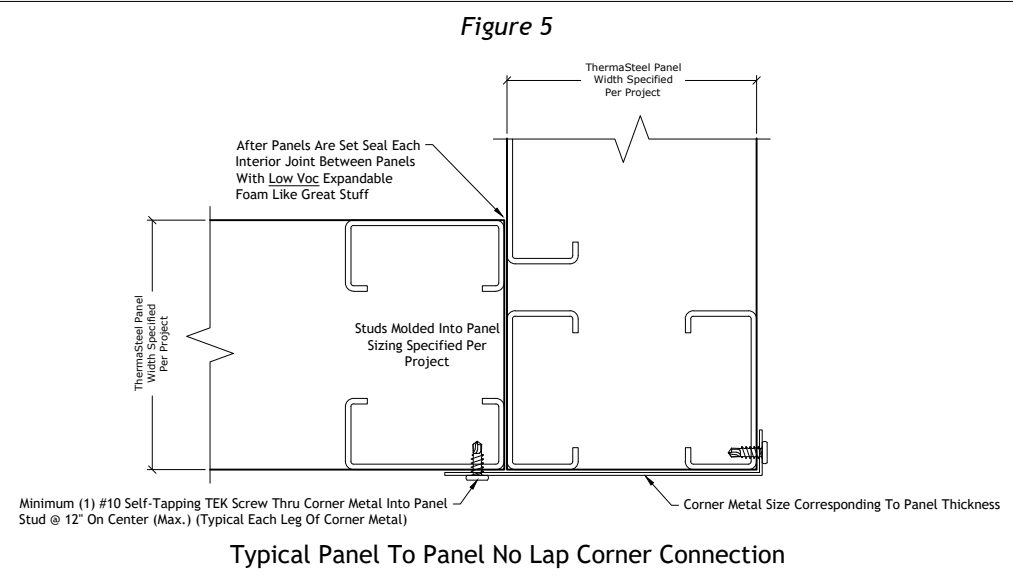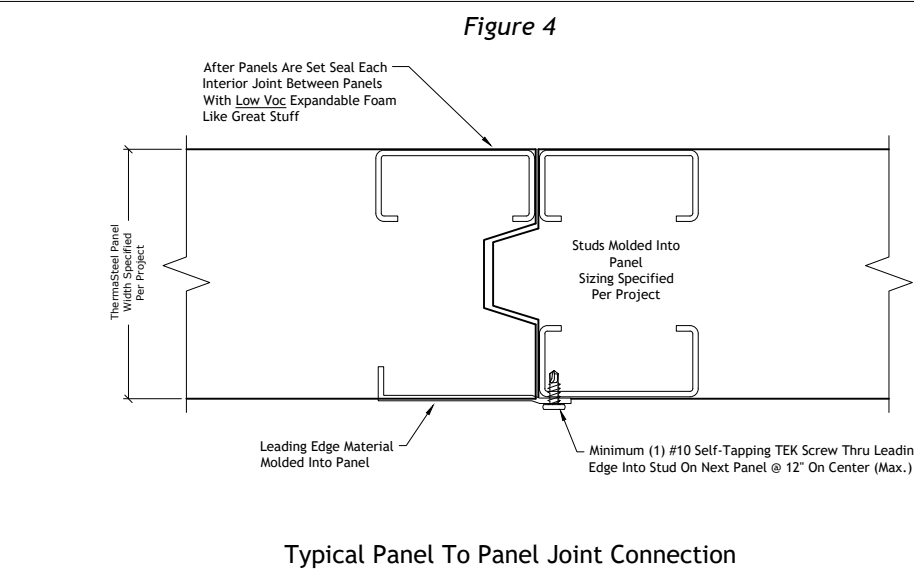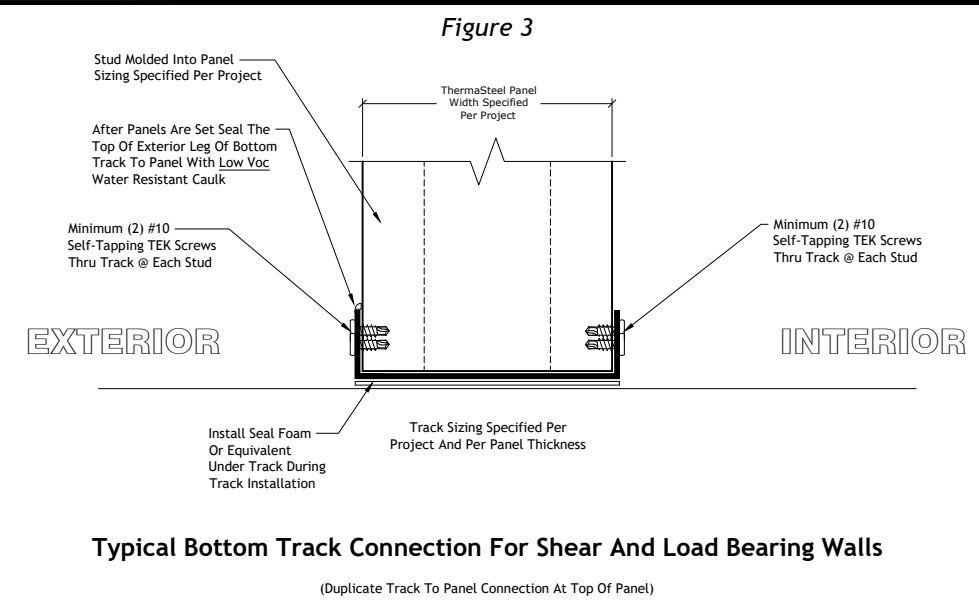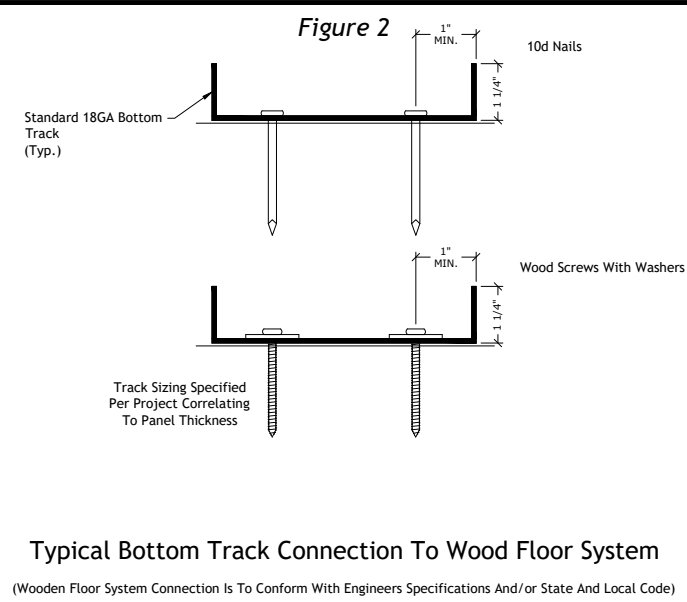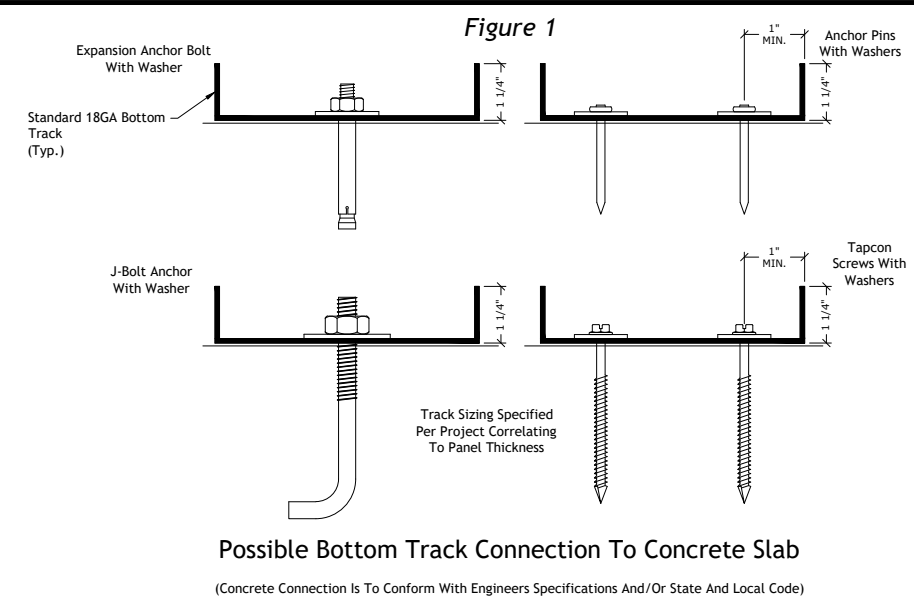

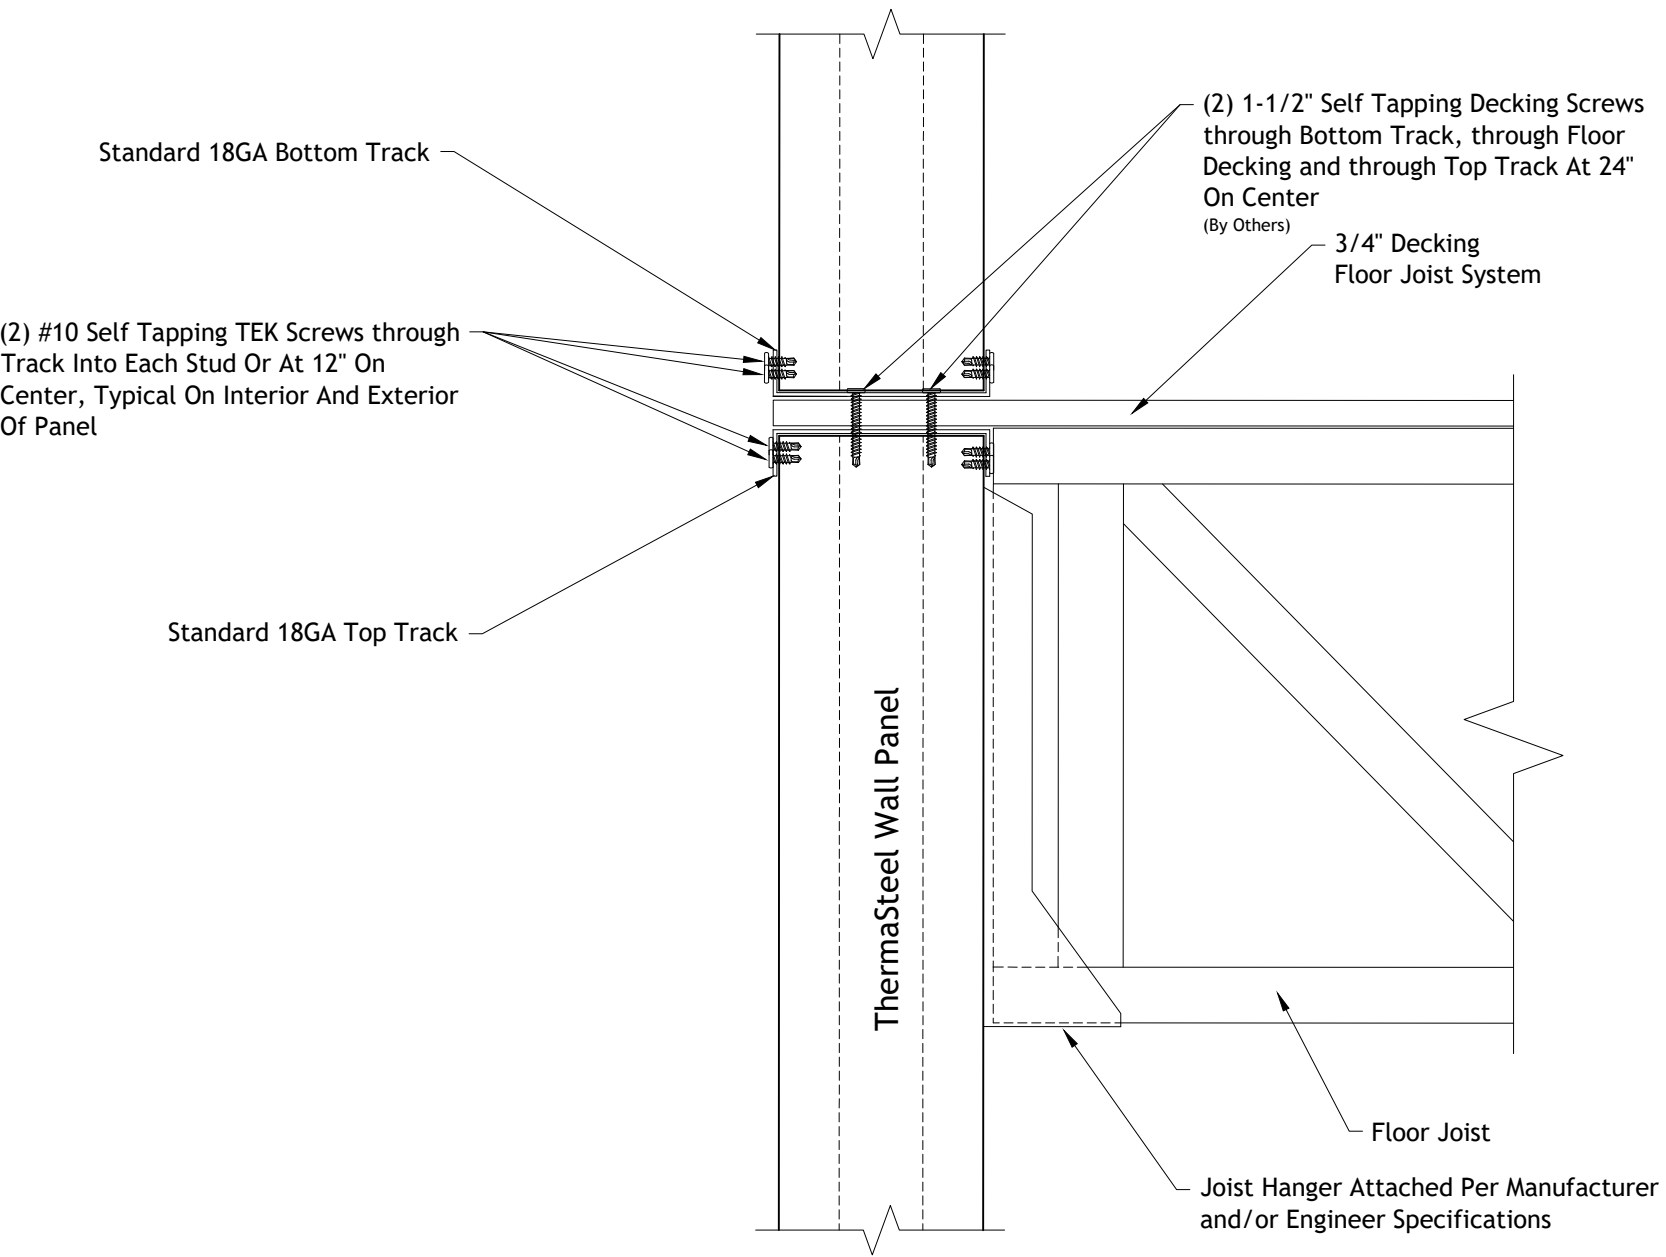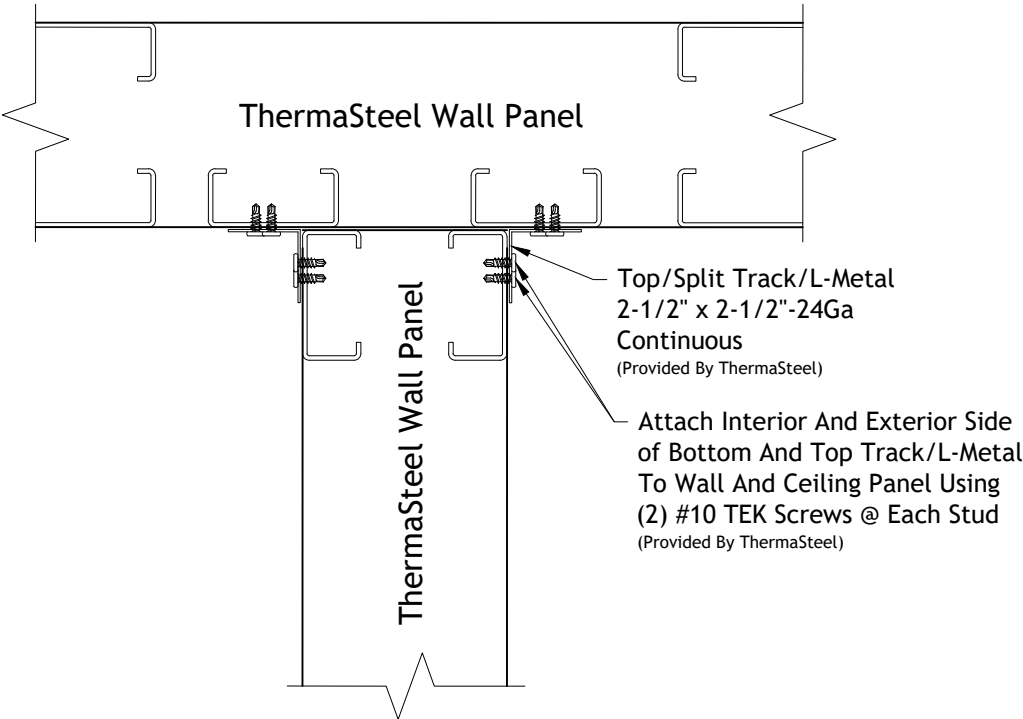

Newtown Road Townhomes (Suggested Connection Detail)



All engineering of the structure, including the ThermaSteel Building System specifications, is to be completed and/or approved by the Project Engineer and/or the Engineer of Record.
THERMASTEEL WALLFRAME SYSTEMS - MANUFACTURED BY THERMASTEEL Inc. - 609 WEST ROCK ROAD RADFORD, VA 24141 - PHONE (540) 633-5000, FAX (540) 633-5001 www.thermasteelinc.com
THE DRAWINGS HEREIN ARE PANEL MANUFACTURING DRAWINGS ONLY. CONTRACTOR SHALL BE SOLELY RESPONSIBLE FOR VERIFYING ALL DIMENSIONS, SITE CONDITIONS, AND THAT ALL STATE AND LOCAL CODE REQUIREMENTS ARE MET.

FINISH DATE:	5/12/2022
REVISION:	
SCALE:	NTS
DESIGNED:	
DRAWN:	PLiu

**THERMASTEEL**
ADVANCED PANEL SYSTEMS

21-245C
JOB NUMBER

SHEET
CD-2

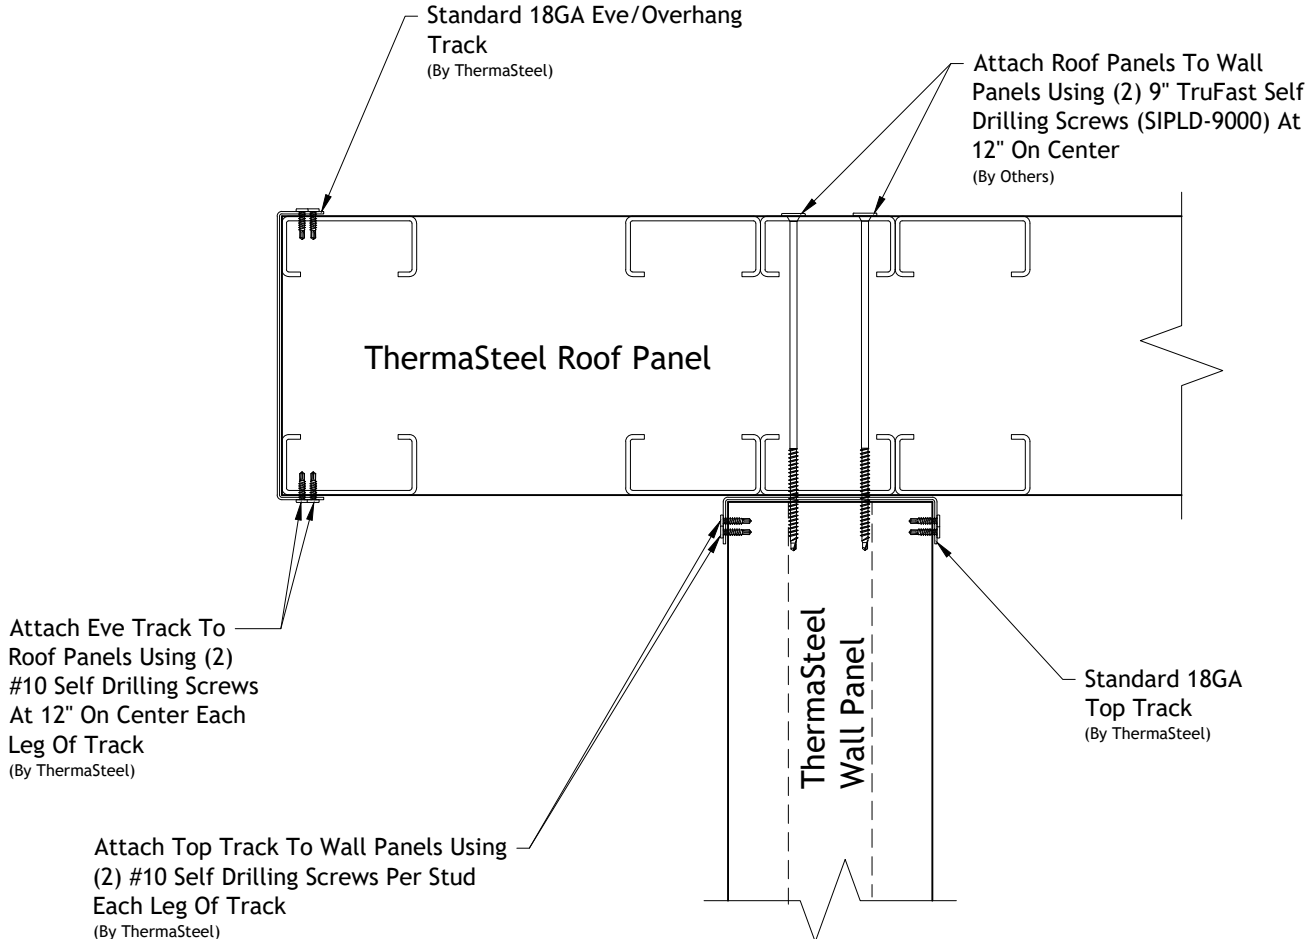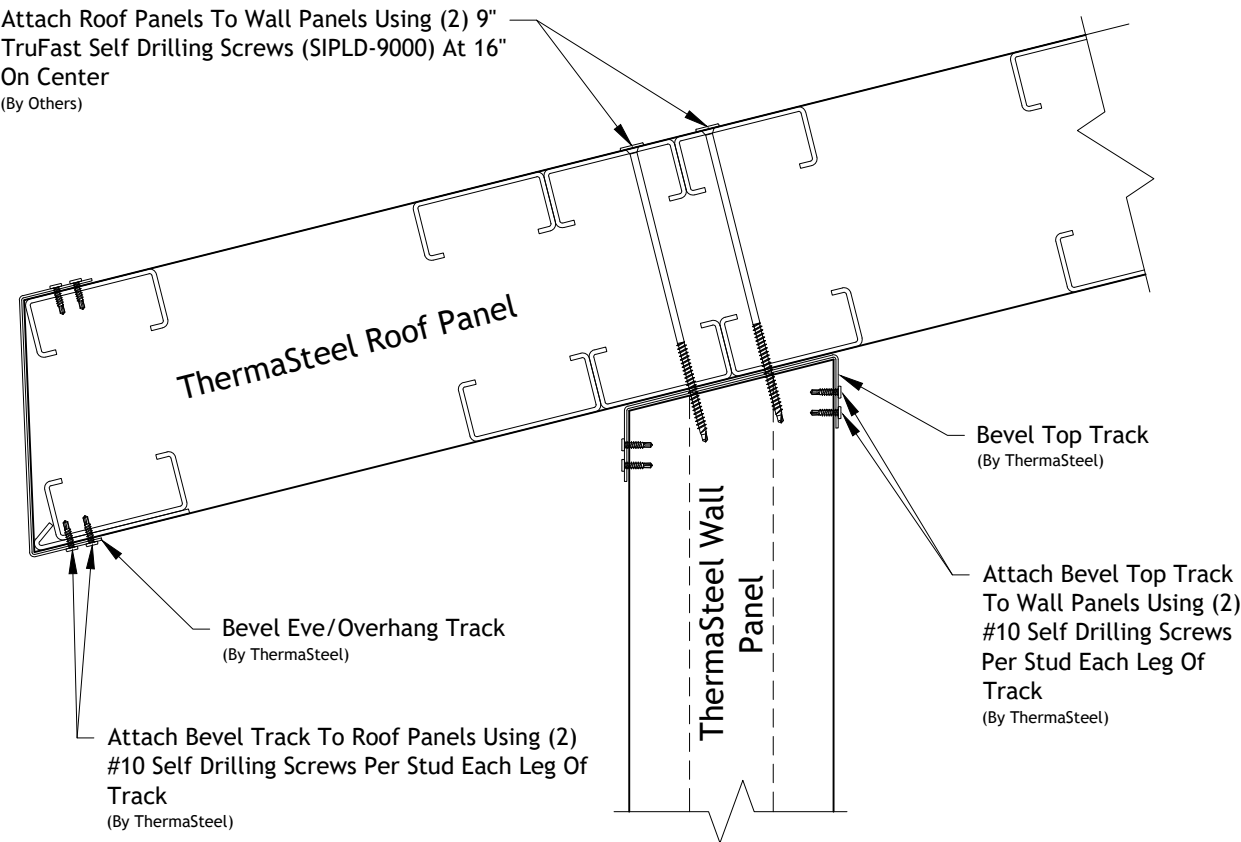

Newtown Road Townhomes (Suggested Connection Detail)



All engineering of the structure, including the ThermaSteel Building System specifications, is to be completed and/or approved by the Project Engineer and/or the Engineer of Record.
THERMASTEEL WALLFRAME SYSTEMS - MANUFACTURED BY THERMASTEEL Inc. - 609 WEST ROCK ROAD RADFORD, VA 24141 - PHONE (540) 633-5000, FAX (540) 633-5001 www.thermasteelinc.com
THE DRAWINGS HEREIN ARE PANEL MANUFACTURING DRAWINGS ONLY. CONTRACTOR SHALL BE SOLELY RESPONSIBLE FOR VERIFYING ALL DIMENSIONS, SITE CONDITIONS, AND THAT ALL STATE AND LOCAL CODE REQUIREMENTS ARE MET.

FINISH DATE:	5/12/2022
REVISION:	
SCALE:	NTS
DESIGNED:	
DRAWN:	PLiu

**THERMASTEEL**
ADVANCED PANEL SYSTEMS

21-245C
JOB NUMBER

SHEET
CD-3

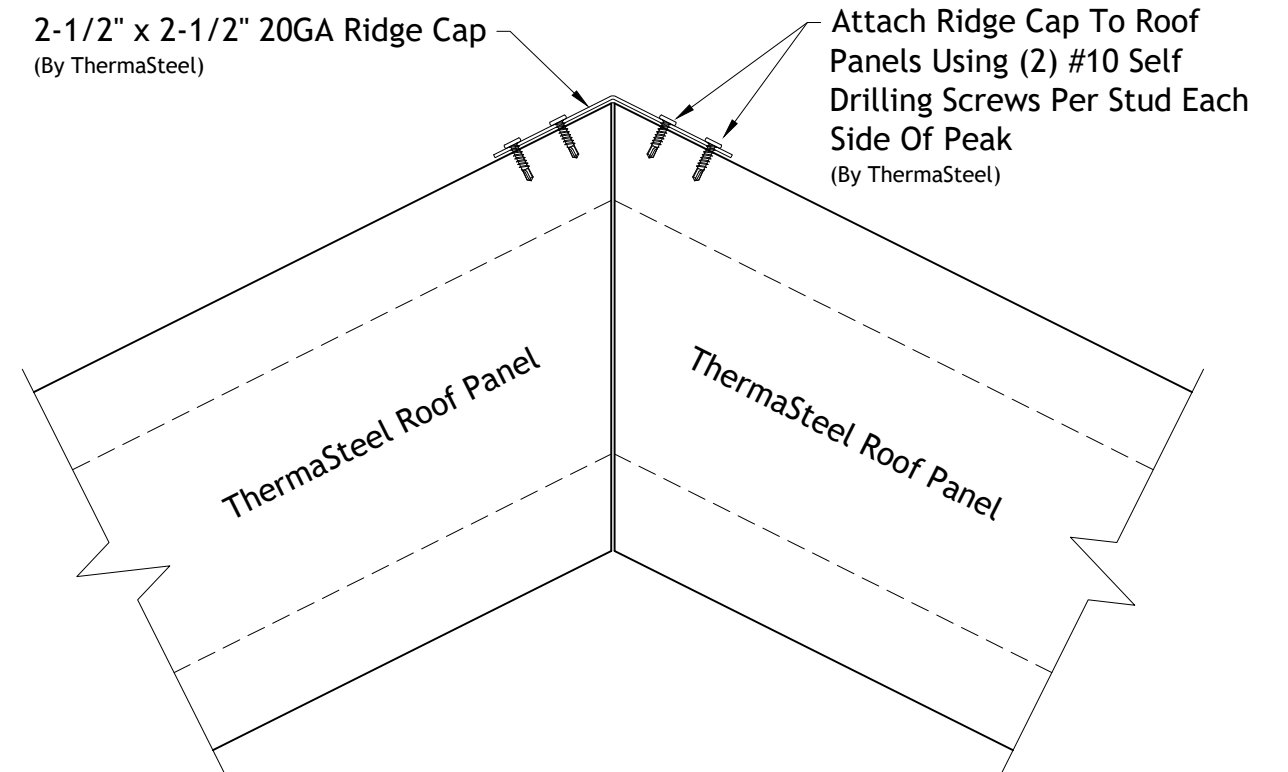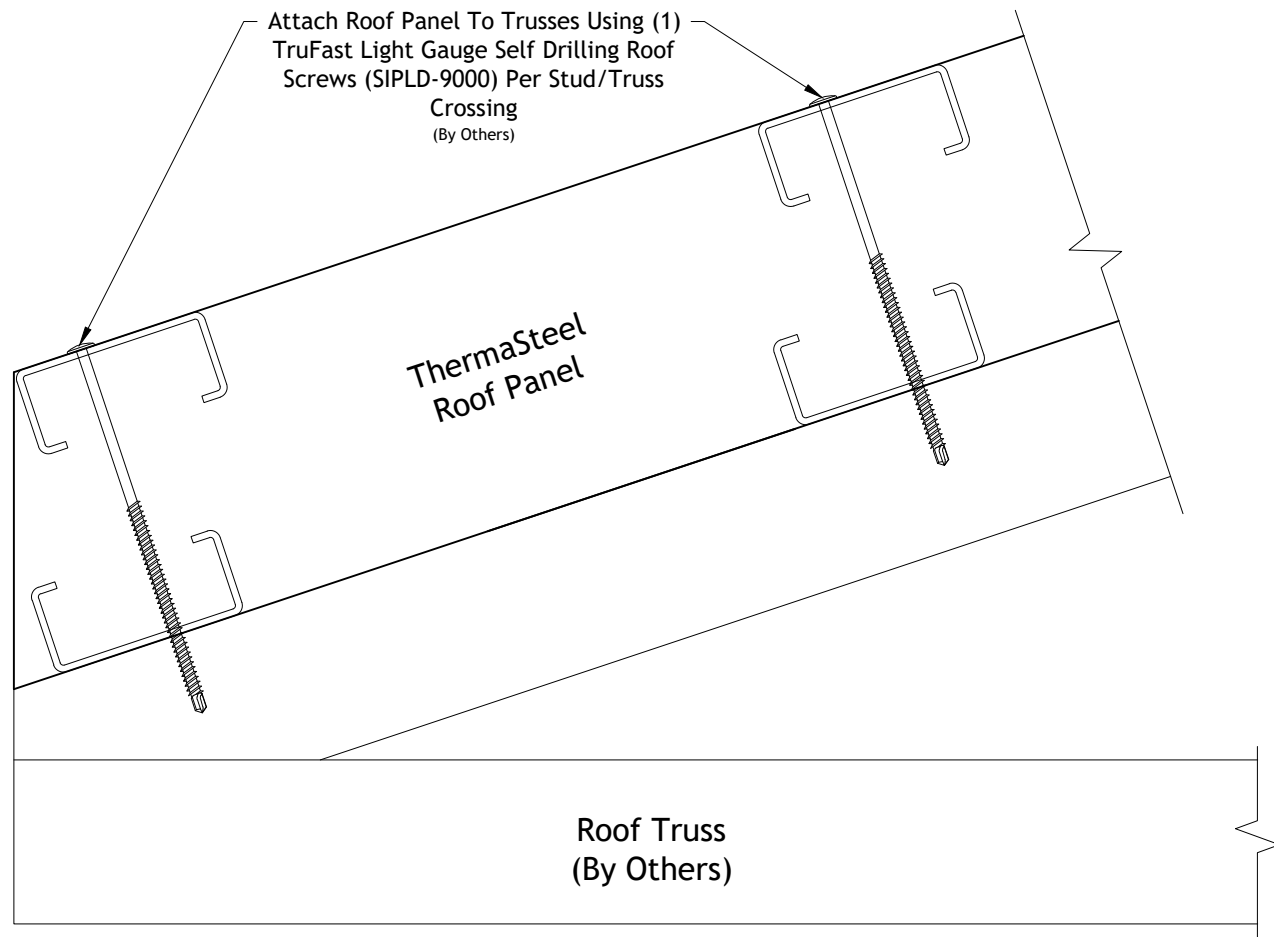

Newtown Road Townhomes (Suggested Connection Detail)


All engineering of the structure, including the ThermaSteel Building System specifications, is to be completed and/or approved by the Project Engineer and/or the Engineer of Record.
THERMASTEEL WALLFRAME SYSTEMS - MANUFACTURED BY THERMASTEEL Inc. - 609 WEST ROCK ROAD RADFORD, VA 24141 - PHONE (540) 633-5000, FAX (540) 633-5001 www.thermasteelinc.com
THE DRAWINGS HEREIN ARE PANEL MANUFACTURING DRAWINGS ONLY. CONTRACTOR SHALL BE SOLELY RESPONSIBLE FOR VERIFYING ALL DIMENSIONS, SITE CONDITIONS, AND THAT ALL STATE AND LOCAL CODE REQUIREMENTS ARE MET.

FINISH DATE:	5/12/2022
REVISION:	
SCALE:	NTS
DESIGNED:	
DRAWN:	PLiu


THERMASTEEL
ADVANCED PANEL SYSTEMS

21-245C
JOB NUMBER

SHEET
CD-4

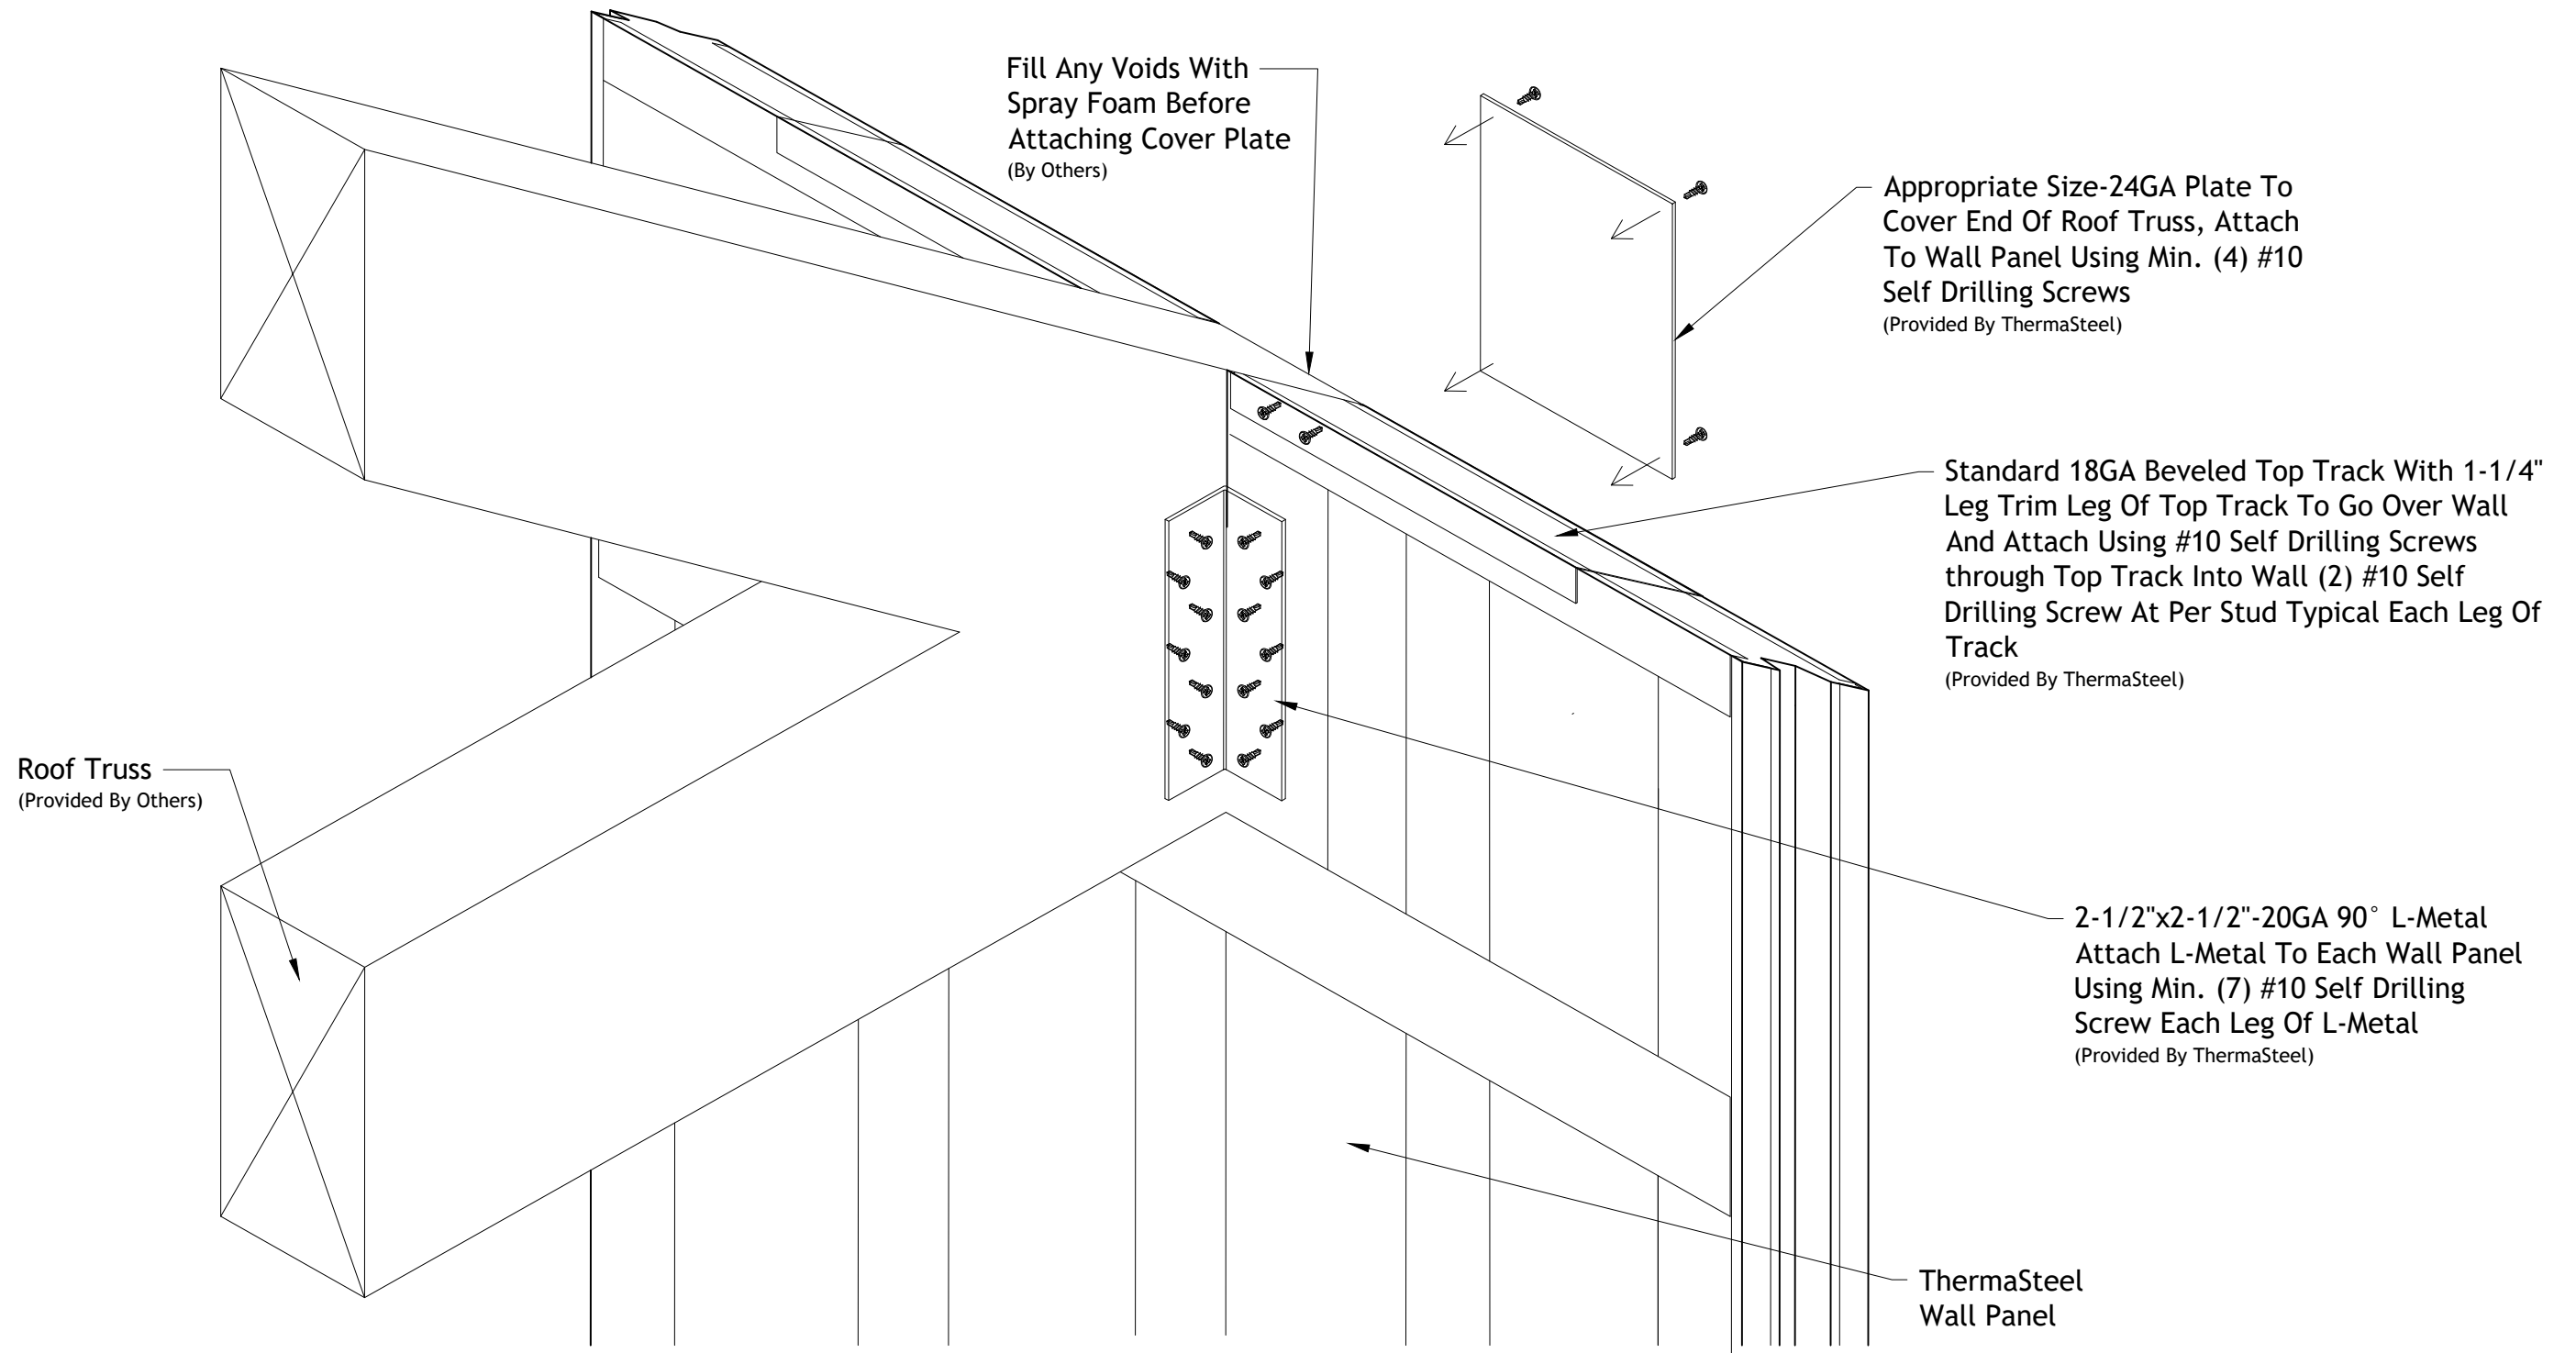

Newtown Road Townhomes (Suggested Connection Detail)

All engineering of the structure, including the ThermaSteel Building System specifications, is to be completed and/or approved by the Project Engineer and/or the Engineer of Record.
THERMASTEEL WALLFRAME SYSTEMS - MANUFACTURED BY THERMASTEEL Inc. - 609 WEST ROCK ROAD RADFORD, VA 24141 - PHONE (540) 633-5000, FAX (540) 633-5001 www.thermasteelinc.com
THE DRAWINGS HEREIN ARE PANEL MANUFACTURING DRAWINGS ONLY. CONTRACTOR SHALL BE SOLELY RESPONSIBLE FOR VERIFYING ALL DIMENSIONS, SITE CONDITIONS, AND THAT ALL STATE AND LOCAL CODE REQUIREMENTS ARE MET.


FINISH DATE:	5/12/2022
REVISION:	
SCALE:	NTS
DESIGNED:	
DRAWN:	PLiu

**THERMASTEEL**
ADVANCED PANEL SYSTEMS

21-245C

JOB NUMBER

SHEET
CD-5

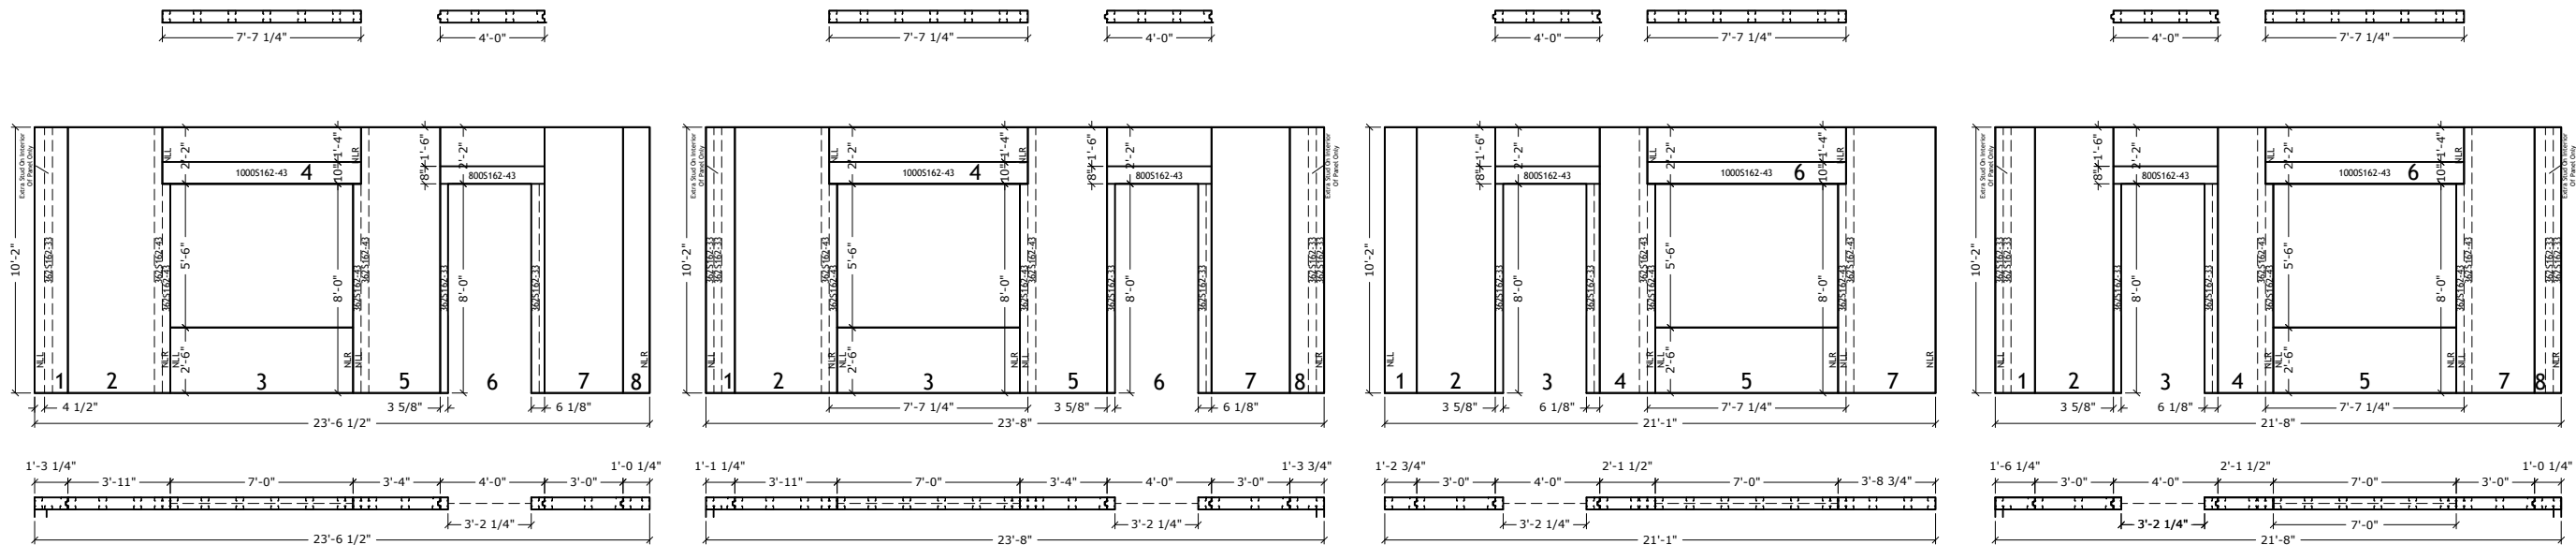

Wall A
5 1/2" PANELS
362S162-33 @ 16" O.C.


Wall B
5 1/2" PANELS
362S162-33 @ 16" O.C.

Wall C
5 1/2" PANELS
362S162-33 @ 16" O.C.


Wall D
5 1/2" PANELS
362S162-33 @ 16" O.C.

Newtown Road Townhomes


FINISH DATE:	5/12/2022	<div><div></div><div>THERMASTEEL</div><div>ADVANCED PANEL SYSTEMS</div><div>21-245C</div><div>JOB NUMBER</div></div>
REVISION:		
SCALE:	NTS	
DESIGNED:		
DRAWN:	PLiu	

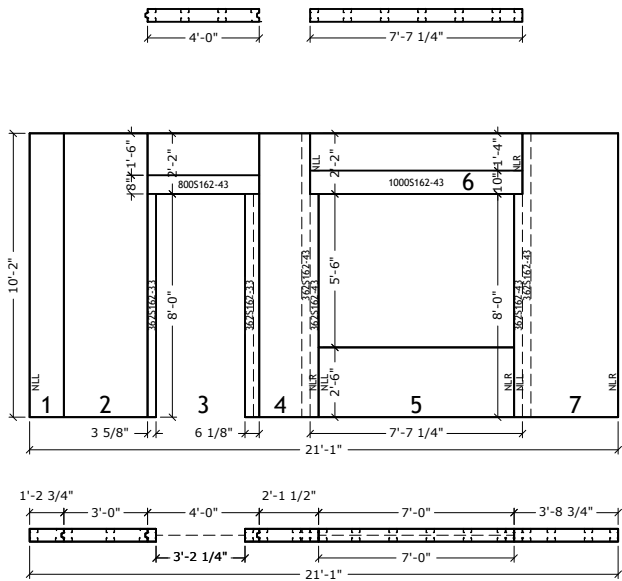


Wall E
5 1/2" PANELS
362S162-33 @ 16" O.C.

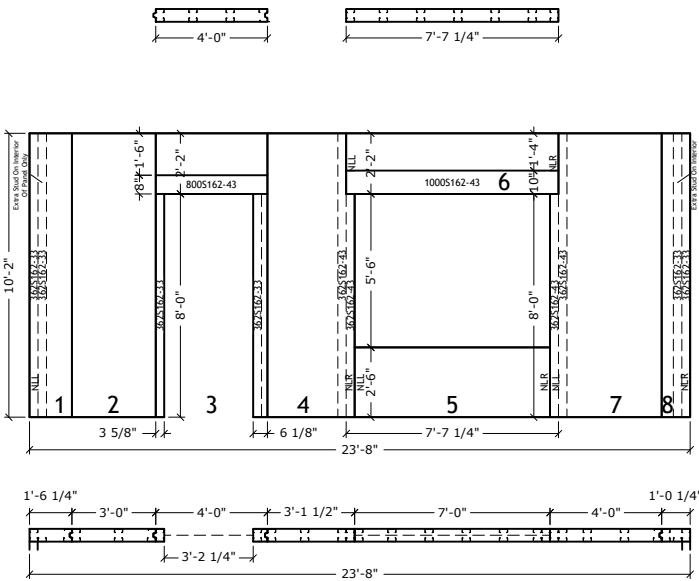

Wall F
5 1/2" PANELS
362S162-33 @ 16" O.C.

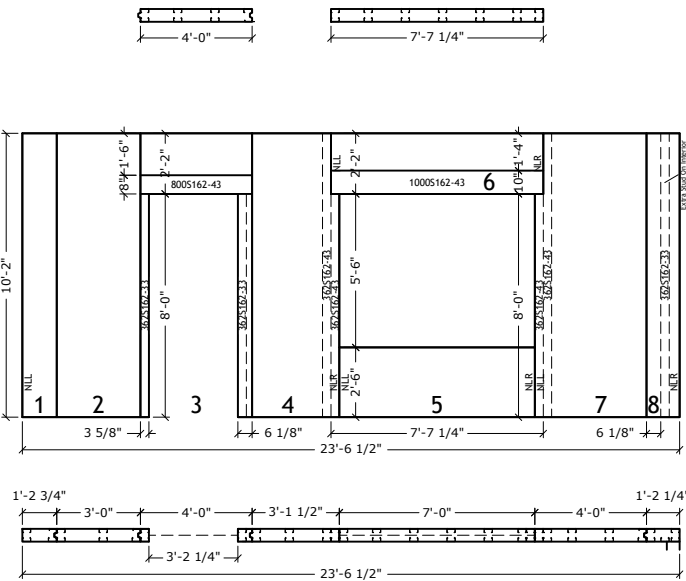

Wall G
5 1/2" PANELS
362S162-33 @ 16" O.C.

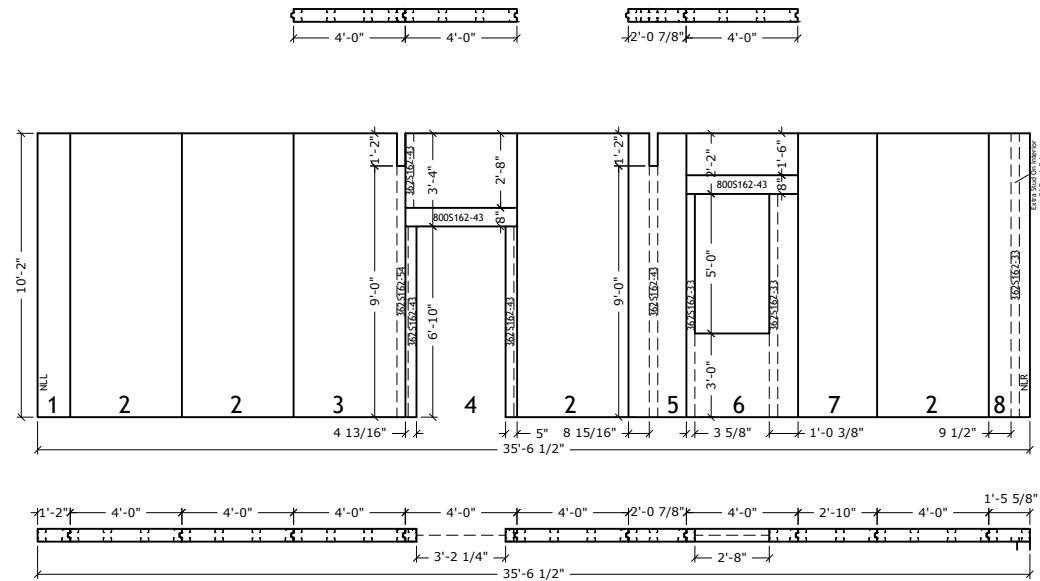

Wall H
5 1/2" PANELS
362S162-33 @ 16" O.C.


Newtown Road Townhomes

All engineering of the structure, including the ThermoSteel Building System specifications, is to be completed and/or approved by the Project Engineer and/or the Engineer of Record.
THERMASTEEL WALLFRAME SYSTEMS - MANUFACTURED BY THERMASTEEL Inc. - 609 WEST ROCK ROAD RADFORD, VA 24141 - PHONE (540) 633-5000, FAX (540) 633-5001 www.thermasteelinc.com
THE DRAWINGS HEREIN ARE PANEL MANUFACTURING DRAWINGS ONLY. CONTRACTOR SHALL BE SOLELY RESPONSIBLE FOR VERIFYING ALL DIMENSIONS, SITE CONDITIONS, AND THAT ALL STATE AND LOCAL CODE REQUIREMENTS ARE MET.

FINISH DATE:	5/12/2022
REVISION:	
SCALE:	NTS
DESIGNED:	
DRAWN:	PLiu

**THERMASTEEL**
ADVANCED PANEL SYSTEMS

21-245C
JOB NUMBER

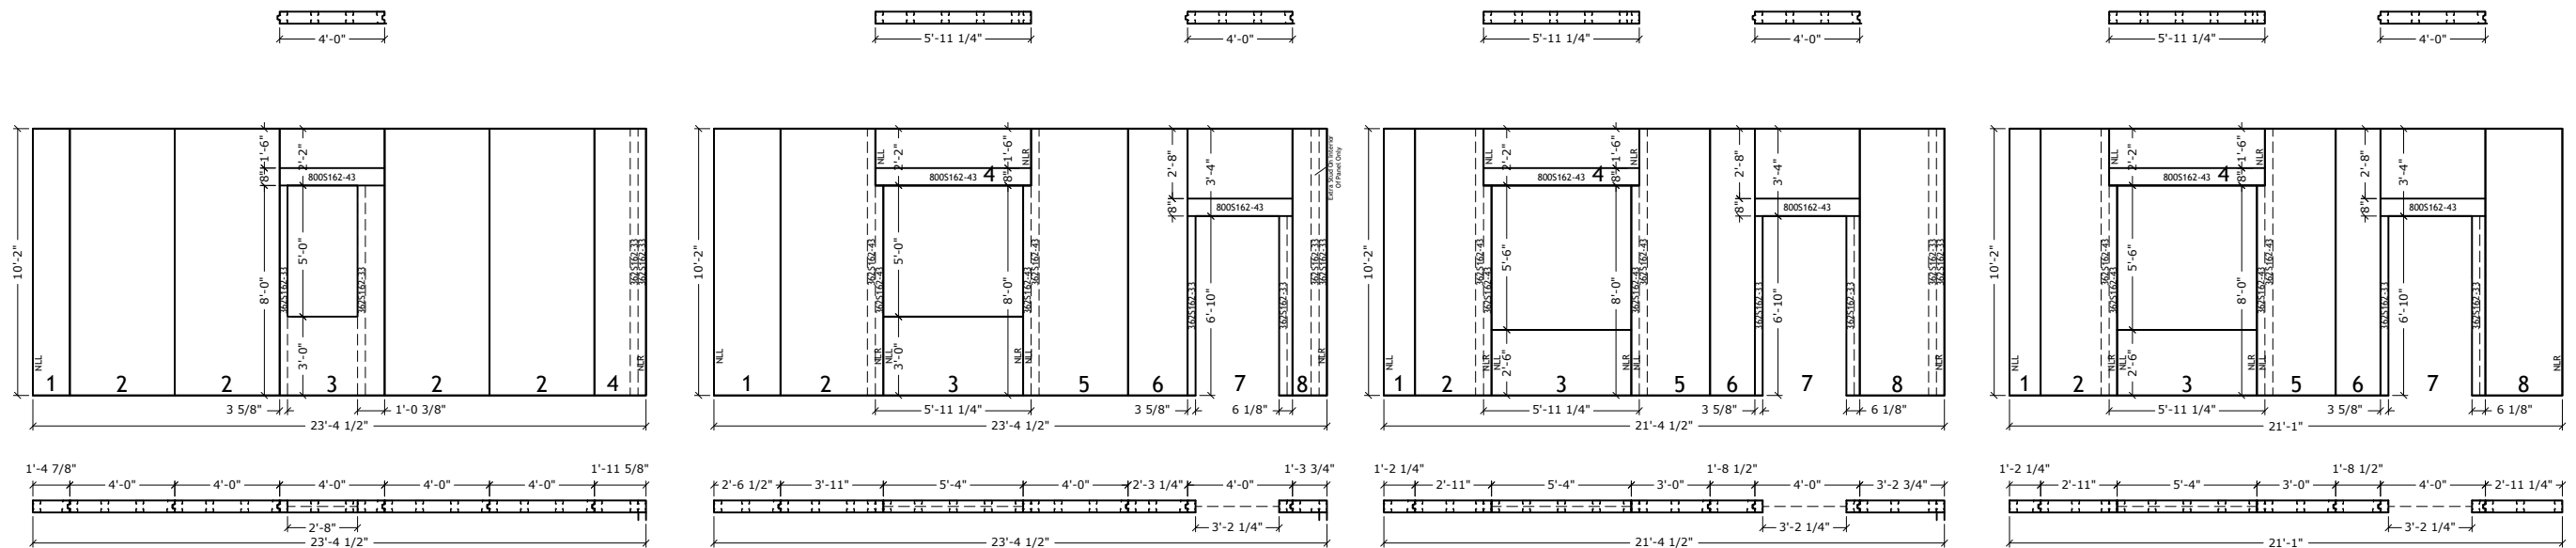

Wall J
5 1/2" PANELS
362S162-33 @ 16" O.C.

Wall K
5 1/2" PANELS
362S162-33 @ 16" O.C.

Wall L
5 1/2" PANELS
362S162-33 @ 16" O.C.


Wall M
5 1/2" PANELS
362S162-33 @ 16" O.C.

Newtown Road Townhomes

FINISH DATE:	5/12/2022
REVISION:	
SCALE:	NTS
DESIGNED:	
DRAWN:	PLiu

**THERMASTEEL™**
ADVANCED PANEL SYSTEMS

21-245C
JOB NUMBER

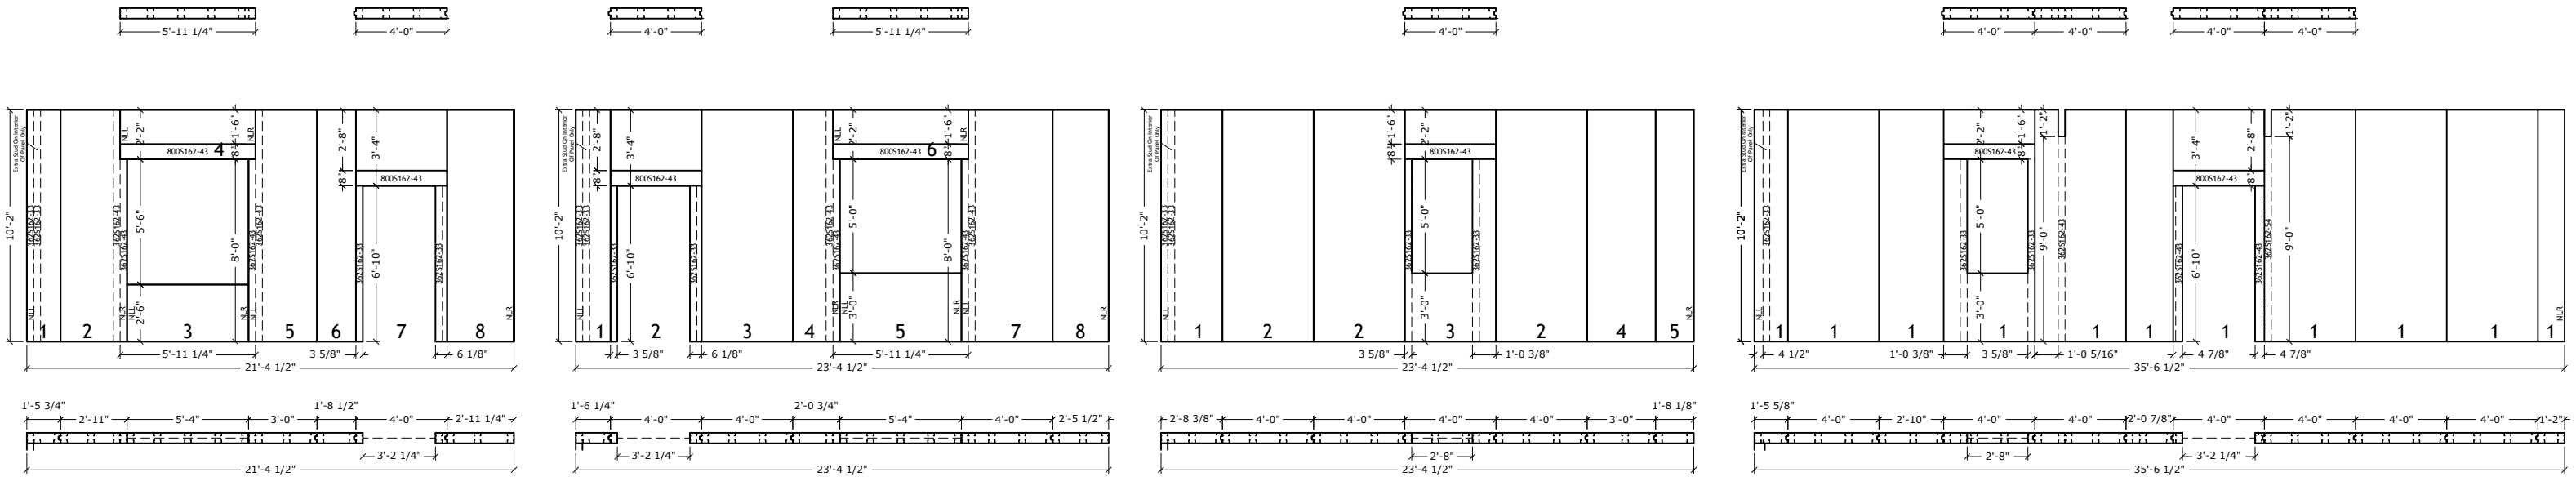

Wall N
5 1/2" PANELS
362S162-33 @ 16" O.C.

Wall P
5 1/2" PANELS
362S162-33 @ 16" O.C.

Wall Q
5 1/2" PANELS
362S162-33 @ 16" O.C.

Wall R
5 1/2" PANELS
362S162-33 @ 16" O.C.

Newtown Road Townhomes

All engineering of the structure, Including the ThermaSteel Building System specifications, is to be completed and/or approved by the Project Engineer and/or the Engineer of Record.
THERMASTEEL WALLFRAME SYSTEMS - MANUFACTURED BY THERMASTEEL Inc. - 609 WEST ROCK ROAD RADFORD, VA 24141 - PHONE (540) 633-5000, FAX (540) 633-5001 www.thermasteelinc.com
THE DRAWINGS HEREIN ARE PANEL MANUFACTURING DRAWINGS ONLY. CONTRACTOR SHALL BE SOLELY RESPONSIBLE FOR VERIFYING ALL DIMENSIONS, SITE CONDITIONS, AND THAT ALL STATE AND LOCAL CODE REQUIREMENTS ARE MET.


FINISH DATE:	5/12/2022
REVISION:	
SCALE:	NTS
DESIGNED:	
DRAWN:	PLiu

**THERMASTEEL**
ADVANCED PANEL SYSTEMS


21-245C
JOB NUMBER

SHEET

4

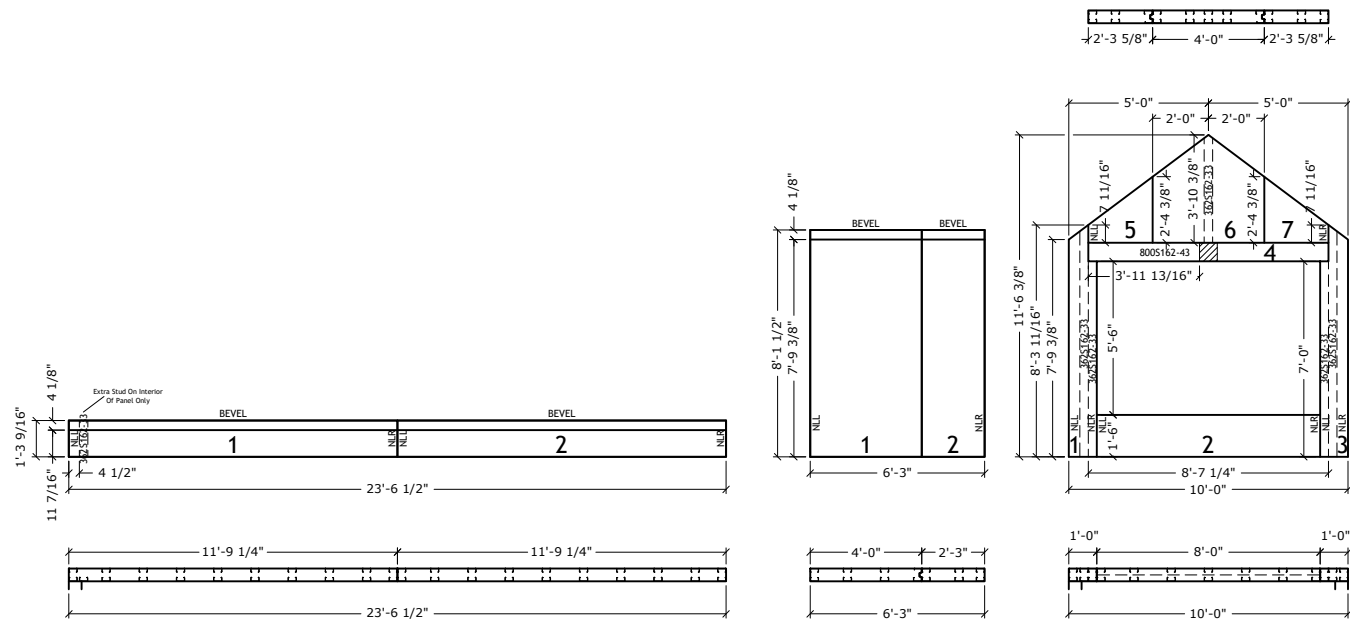


Wall 2A
5 1/2" PANELS
362S162-33 @ 16" O.C.

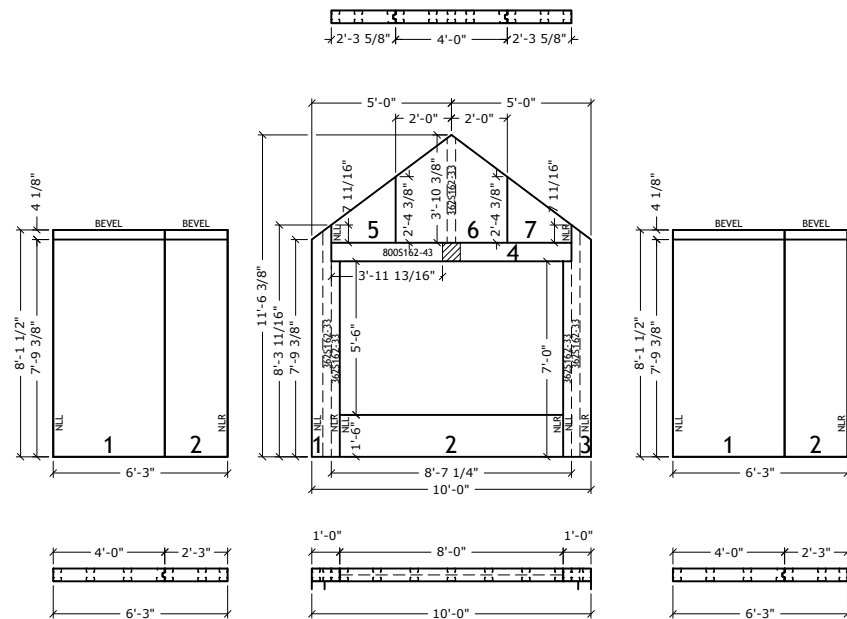


Wall 2B
5 1/2" PANELS
362S162-33 @ 16" O.C.

Wall 2C
5 1/2" PANELS
362S162-33 @ 16" O.C.

Wall 2D
5 1/2" PANELS
362S162-33 @ 16" O.C.

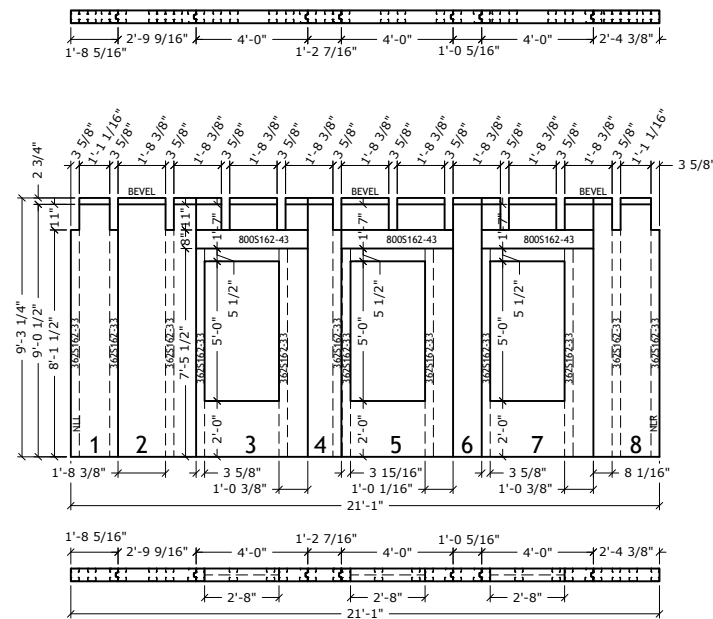

Wall 2E
5 1/2" PANELS
362S162-33 @ 16" O.C.

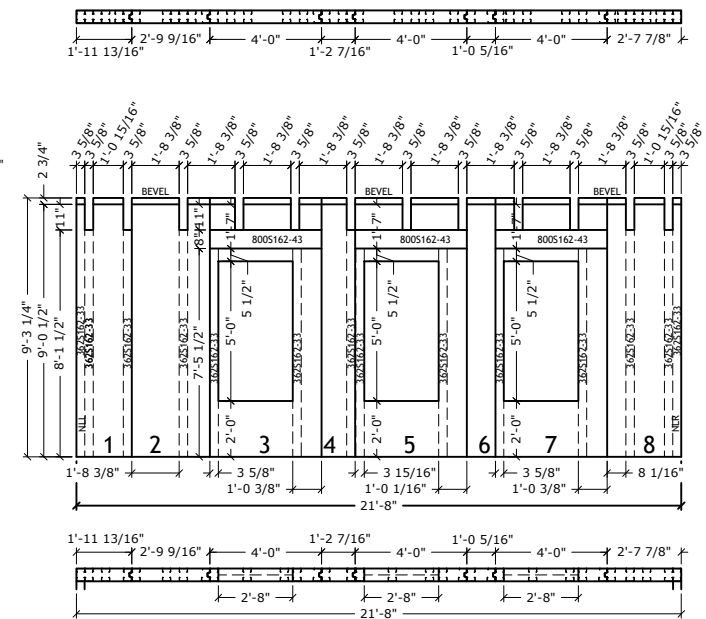

Wall 2F
5 1/2" PANELS
362S162-33 @ 16" O.C.

Newtown Road Townhomes


FINISH DATE:	5/12/2022
REVISION:	
SCALE:	NTS
DESIGNED:	
DRAWN:	PLiu

THERMASTEEL
ADVANCED PANEL SYSTEMS


21-245C
JOB NUMBER

SHEET


5

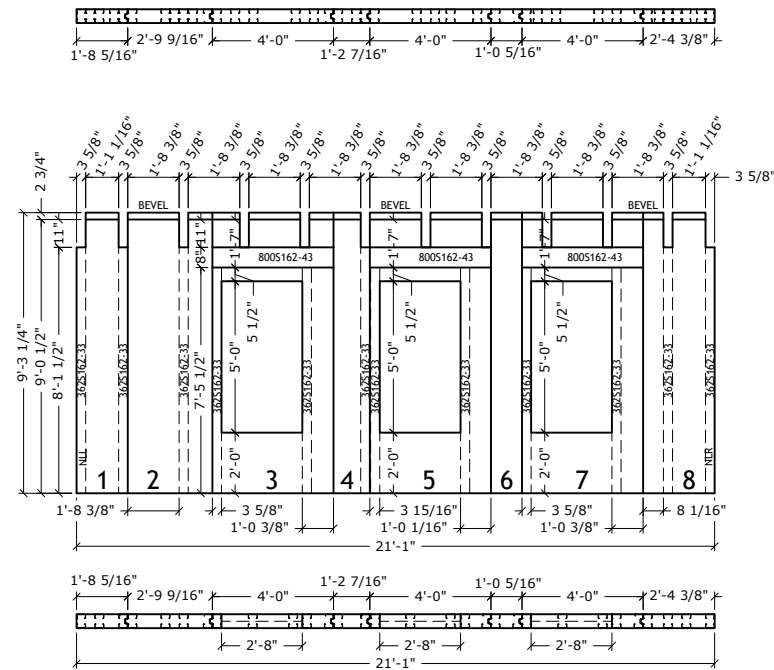


Wall 2G
5 1/2" PANELS
362S162-33 @ 16" O.C.

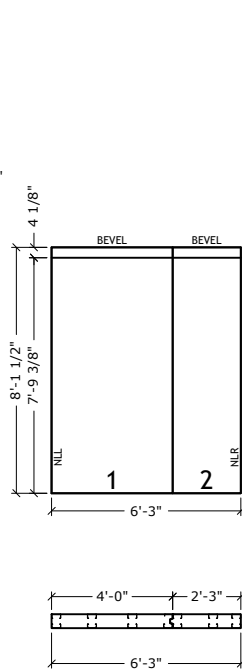


Wall 2H
5 1/2" PANELS
362S162-33 @ 16" O.C.

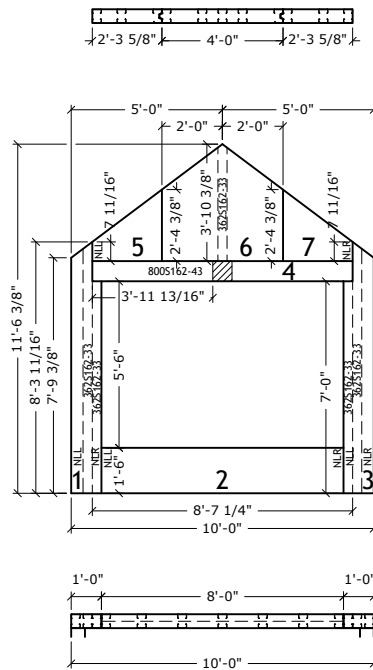

Wall 2J
5 1/2" PANELS
362S162-33 @ 16" O.C.

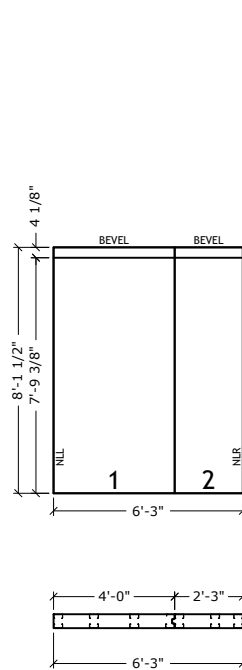

Wall 2K
5 1/2" PANELS
362S162-33 @ 16" O.C.

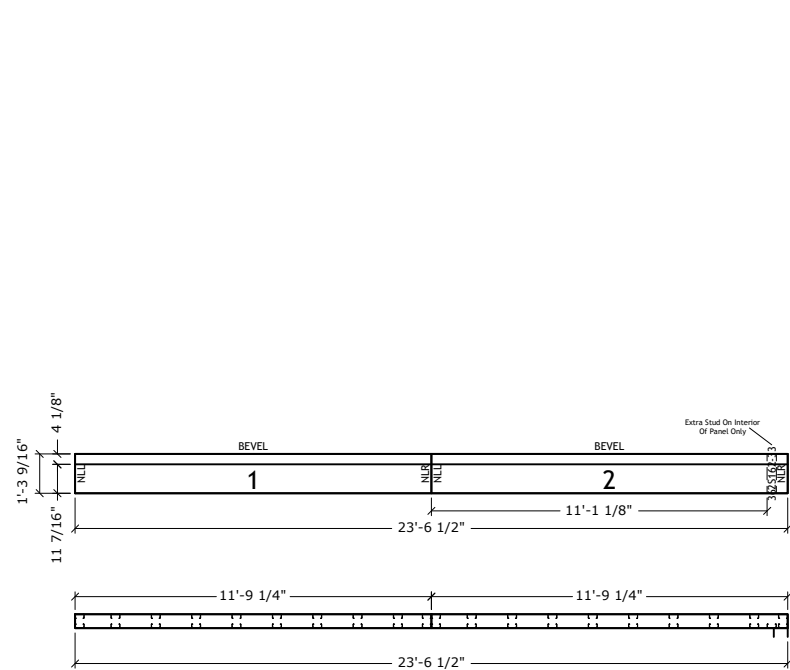


Wall 2L
5 1/2" PANELS
362S162-33 @ 16" O.C.

Newtown Road Townhomes


FINISH DATE:	5/12/2022
REVISION:	
SCALE:	NTS
DESIGNED:	
DRAWN:	PLiu

**THERMASTEEL™**
ADVANCED PANEL SYSTEMS


21-245C
JOB NUMBER

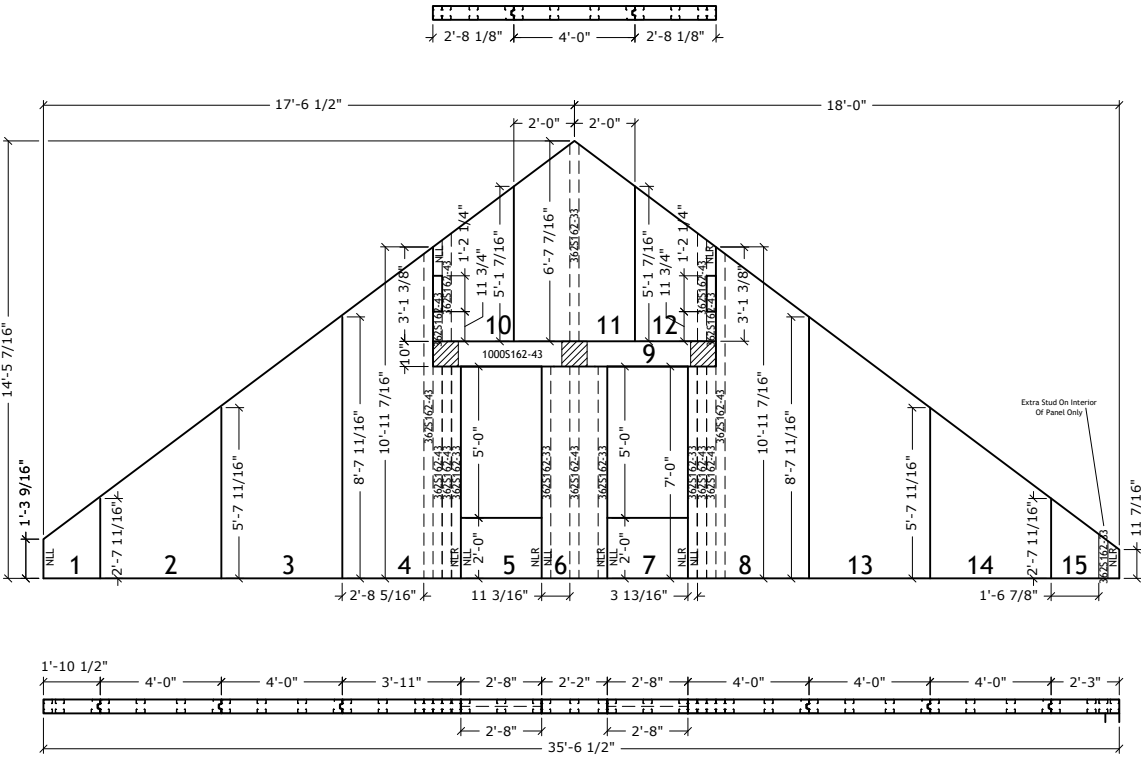


Wall 2M
5 1/2" PANELS
362S162-33 @ 16" O.C.

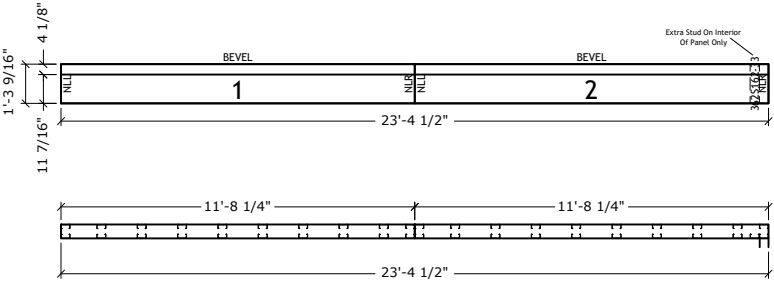

Wall 2N
5 1/2" PANELS
362S162-33 @ 16" O.C.

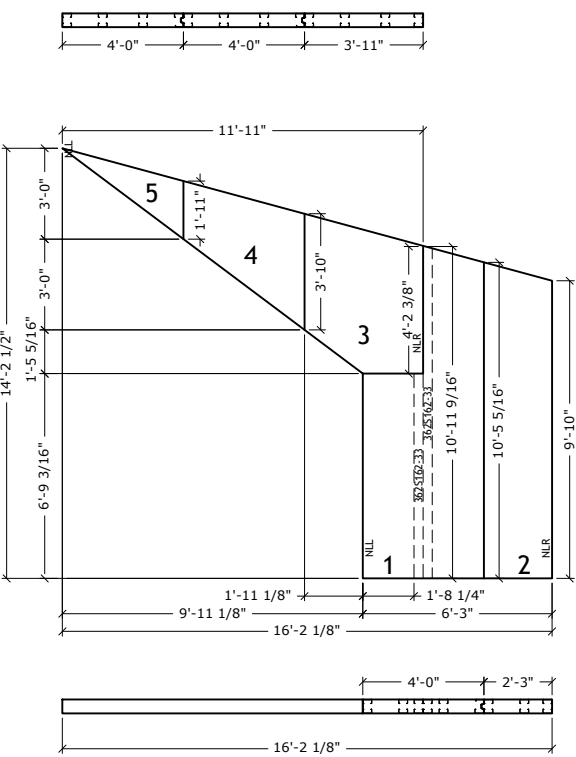

Wall 2P
5 1/2" PANELS
362S162-33 @ 16" O.C.

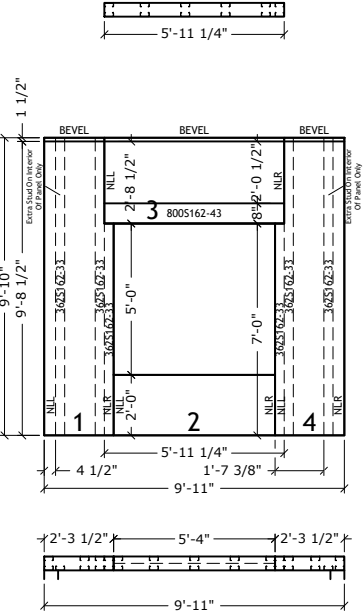


Wall 2Q
5 1/2" PANELS
362S162-33 @ 16" O.C.


Newtown Road Townhomes

FINISH DATE:	5/12/2022
REVISION:	
SCALE:	NTS
DESIGNED:	
DRAWN:	PLiu


THERMASTEEL
ADVANCED PANEL SYSTEMS
21-245C
JOB NUMBER

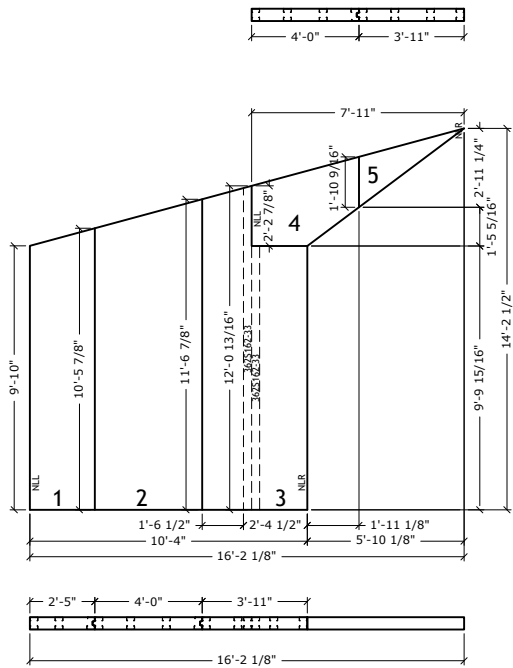


Wall 2R
5 1/2" PANELS
362S162-33 @ 16" O.C.

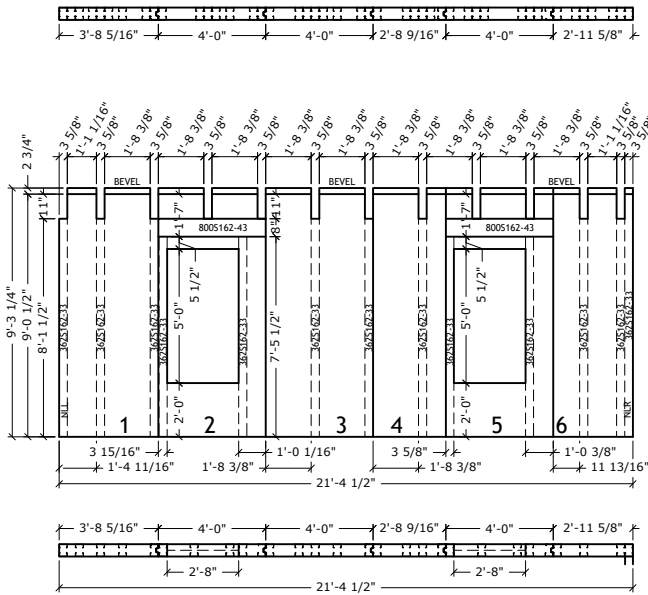


Wall 2S
5 1/2" PANELS
362S162-33 @ 16" O.C.

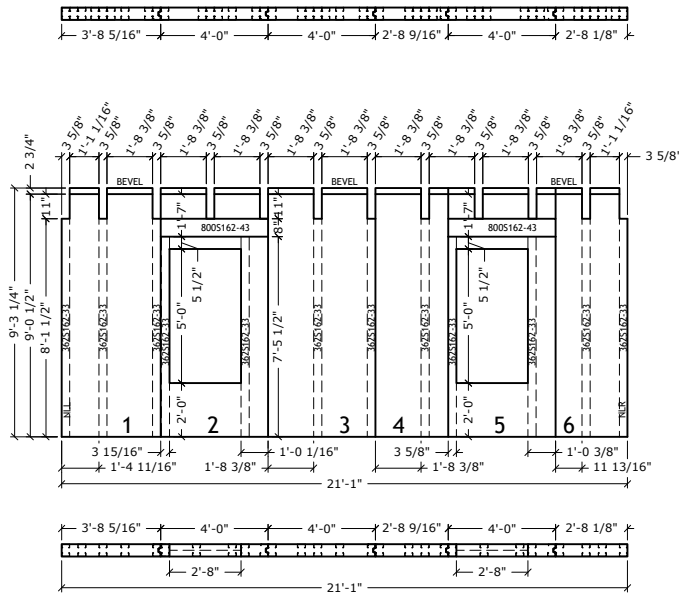

Wall 2T
5 1/2" PANELS
362S162-33 @ 16" O.C.

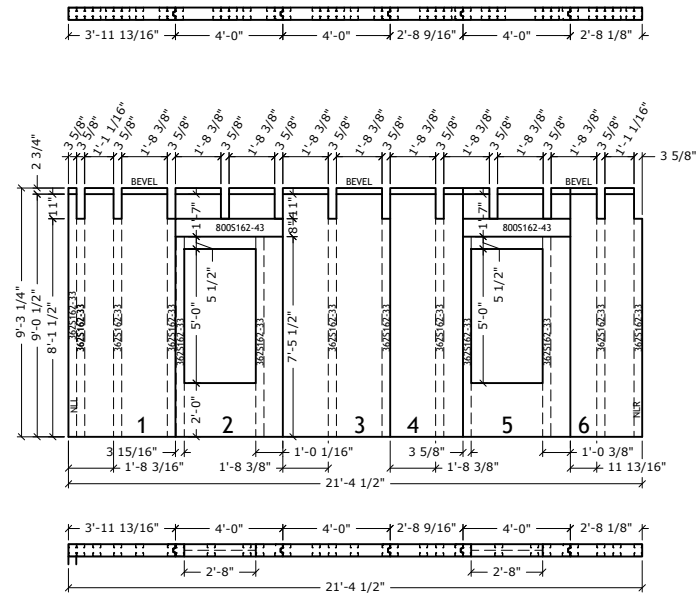

Wall 2U
5 1/2" PANELS
362S162-33 @ 16" O.C.

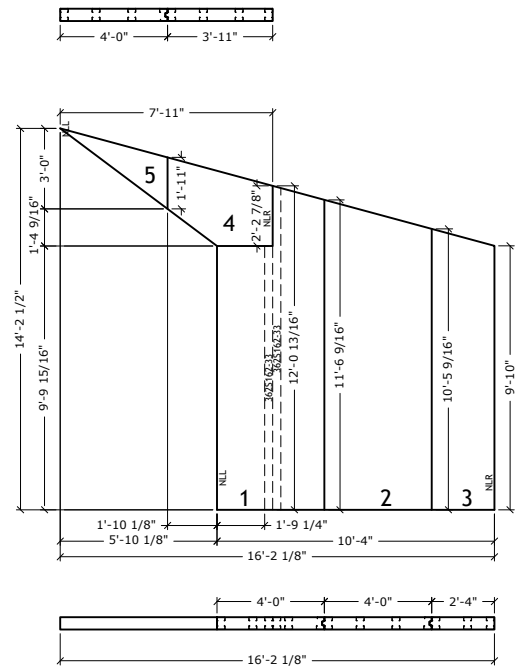

Wall 2V
5 1/2" PANELS
362S162-33 @ 16" O.C.

Newtown Road Townhomes

All engineering of the structure, Including the ThermaSteel Building System specifications, is to be completed and/or approved by the Project Engineer and/or the Engineer of Record.
THERMASTEEL WALLFRAME SYSTEMS - MANUFACTURED BY THERMASTEEL Inc. - 609 WEST ROCK ROAD RADFORD, VA 24141 - PHONE (540) 633-5000, FAX (540) 633-5001 www.thermasteelinc.com
THE DRAWINGS HEREIN ARE PANEL MANUFACTURING DRAWINGS ONLY. CONTRACTOR SHALL BE SOLELY RESPONSIBLE FOR VERIFYING ALL DIMENSIONS, SITE CONDITIONS, AND THAT ALL STATE AND LOCAL CODE REQUIREMENTS ARE MET.

FINISH DATE:	5/12/2022
REVISION:	
SCALE:	NTS
DESIGNED:	
DRAWN:	PLiu


THERMASTEEL
ADVANCED PANEL SYSTEMS

21-245C


JOB NUMBER

SHEET


8

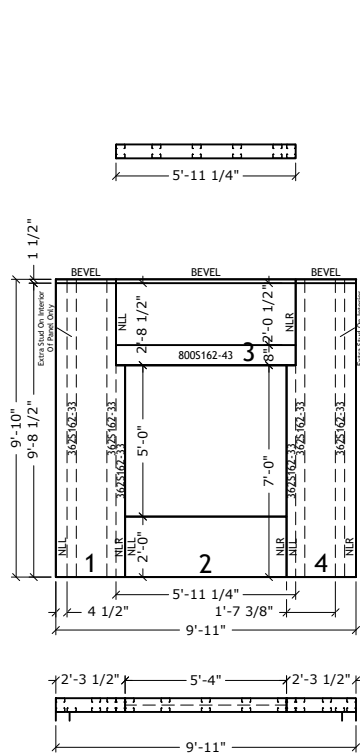


Wall 2W
5 1/2" PANELS
362S162-33 @ 16" O.C.

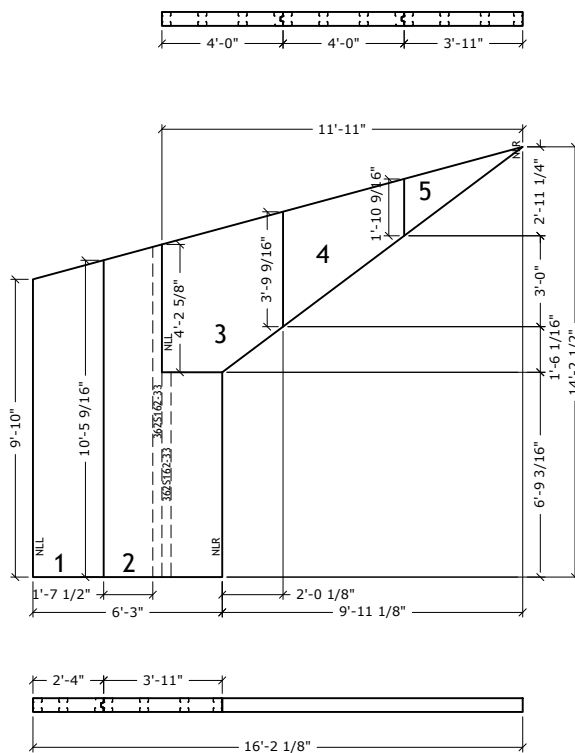

Wall 2X
5 1/2" PANELS
362S162-33 @ 16" O.C.

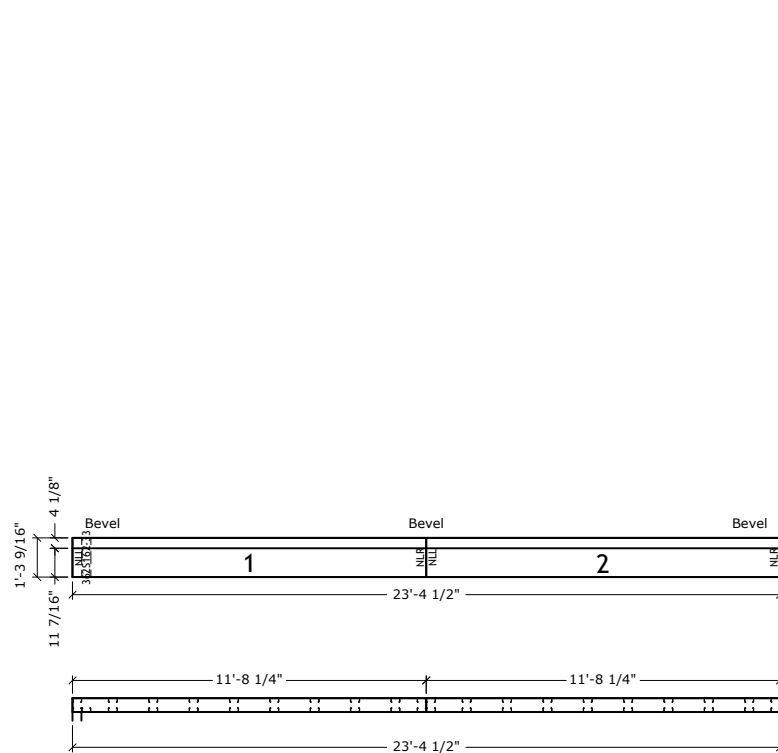

Wall 2Y
5 1/2" PANELS
362S162-33 @ 16" O.C.

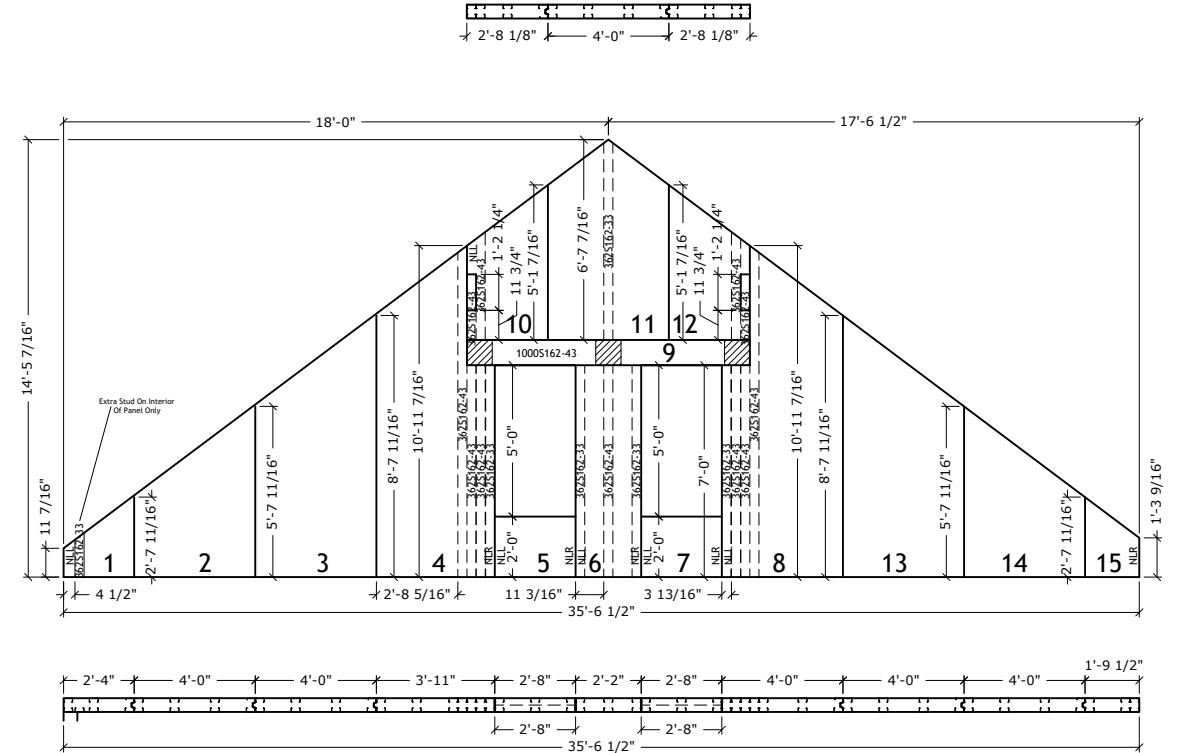


Wall 2Z
5 1/2" PANELS
362S162-33 @ 16" O.C.

Newtown Road Townhomes

FINISH DATE:	5/12/2022
REVISION:	
SCALE:	NTS
DESIGNED:	
DRAWN:	PLiu

THERMASTEEL
ADVANCED PANEL SYSTEMS


21-245C
JOB NUMBER

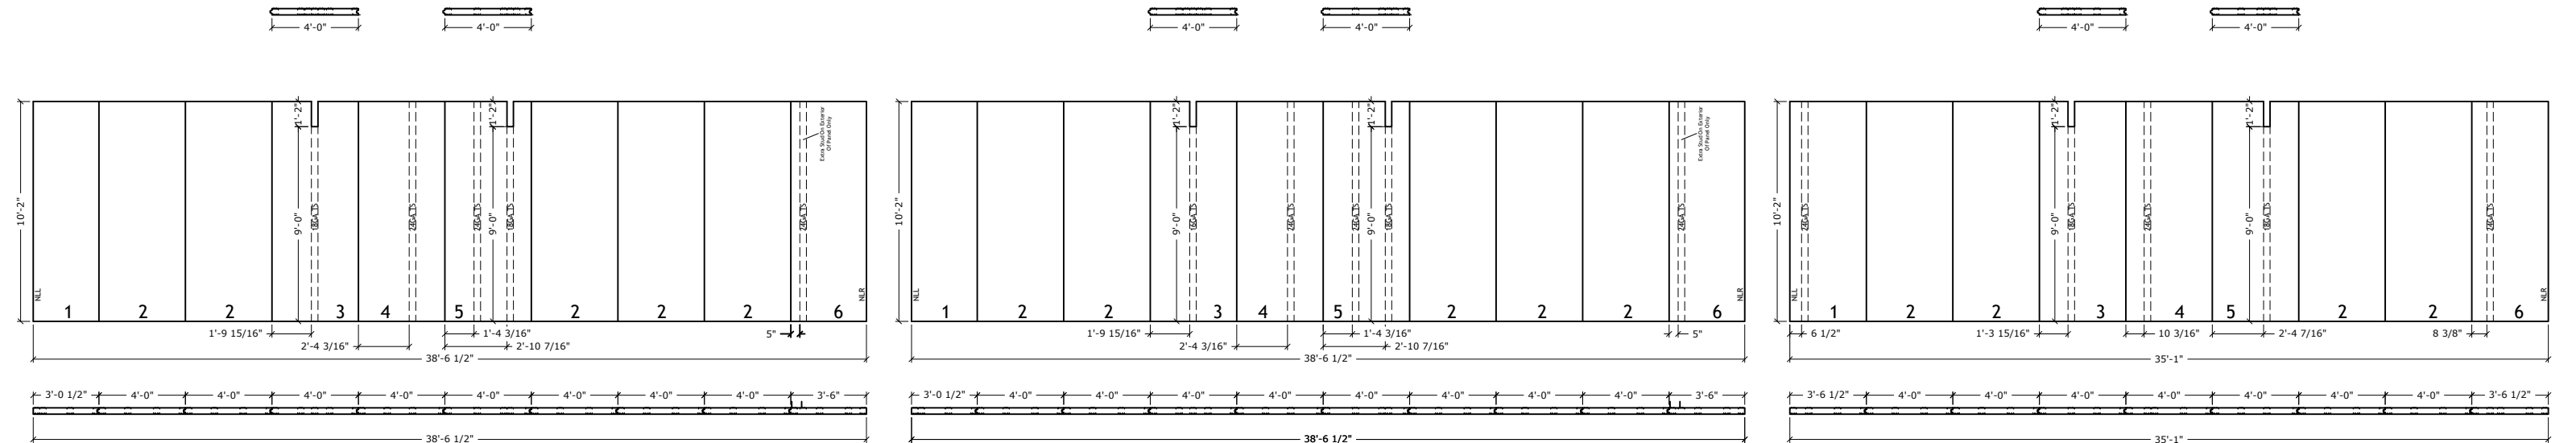

Wall 1
3 1/2" PANELS
24GA TS@ 16" O.C.
(1.5PSF EPS DENSITY)

Wall 2
3 1/2" PANELS
24GA TS@ 16" O.C.
(1.5PSF EPS DENSITY)

Wall 3
3 1/2" PANELS
24GA TS@ 16" O.C.
(1.5PSF EPS DENSITY)

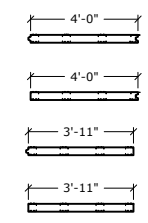

Newtown Road Townhomes

All engineering of the structure, including the ThermaSteel Building System specifications, is to be completed and/or approved by the Project Engineer and/or the Engineer of Record.
THERMASTEEL WALLFRAME SYSTEMS - MANUFACTURED BY THERMASTEEL Inc. - 609 WEST ROCK ROAD RADFORD, VA 24141 - PHONE (540) 633-5000, FAX (540) 633-5001 www.thermasteelinc.com
THE DRAWINGS HEREIN ARE PANEL MANUFACTURING DRAWINGS ONLY. CONTRACTOR SHALL BE SOLELY RESPONSIBLE FOR VERIFYING ALL DIMENSIONS, SITE CONDITIONS, AND THAT ALL STATE AND LOCAL CODE REQUIREMENTS ARE MET.


FINISH DATE:	5/12/2022
REVISION:	
SCALE:	NTS
DESIGNED:	
DRAWN:	PLiu

THERMASTEEL


ADVANCED PANEL SYSTEMS

21-245C


JOB NUMBER

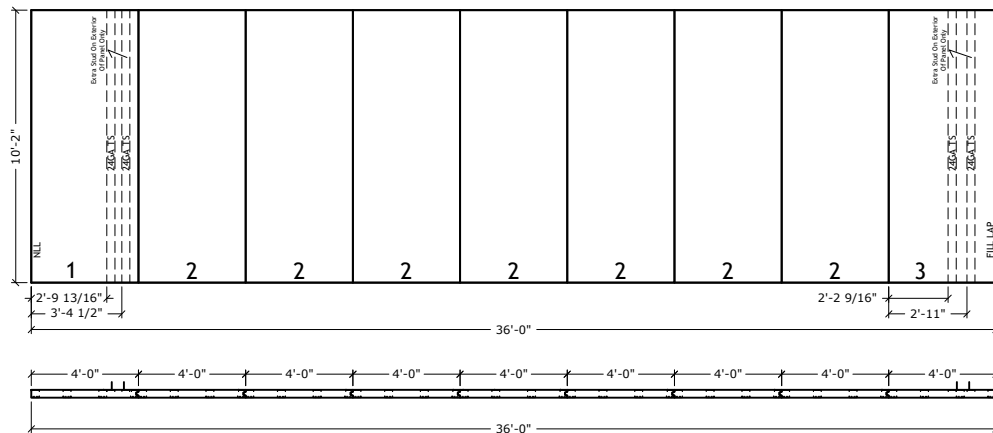

Wall 4
3 1/2" PANELS
24GA TS @ 16" O.C.
(1.5PSF EPS DENSITY)

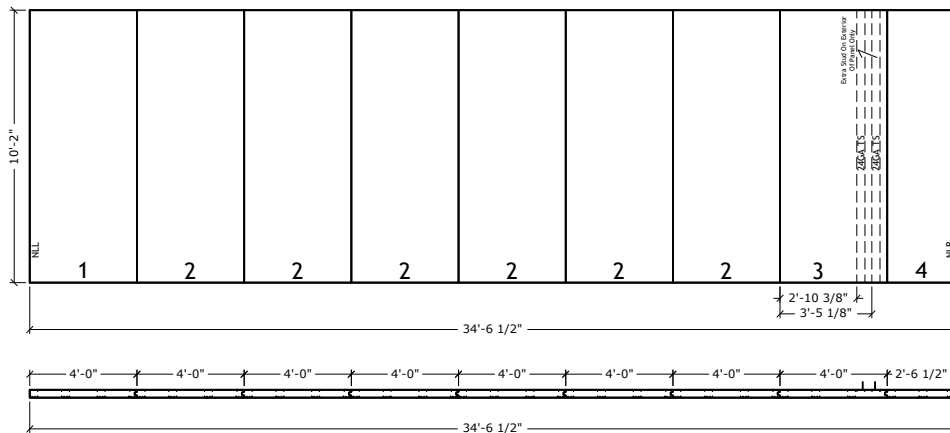

Wall 5
3 1/2" PANELS
24GA TS @ 16" O.C.
(1.5PSF EPS DENSITY)

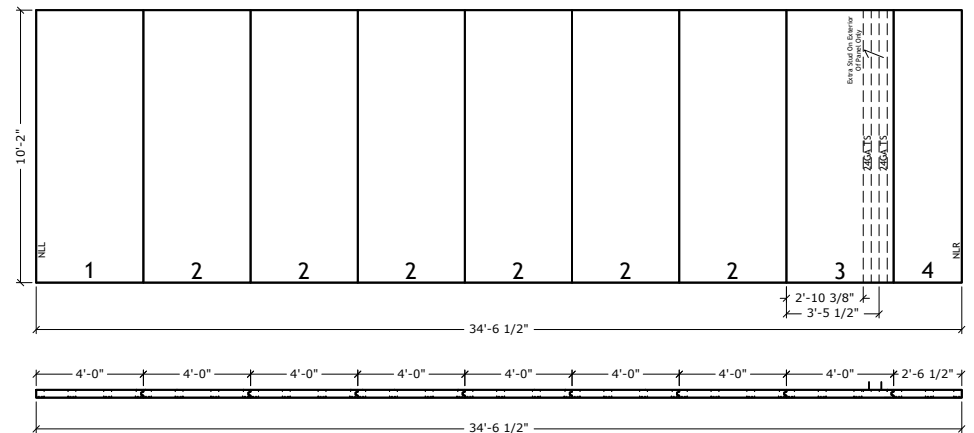


Wall 6
3 1/2" PANELS
24GA TS @ 16" O.C.
(1.5PSF EPS DENSITY)

Newtown Road Townhomes


FINISH DATE:	5/12/2022
REVISION:	
SCALE:	NTS
DESIGNED:	
DRAWN:	PLiu

**THERMASTEEL**
ADVANCED PANEL SYSTEMS


21-245C
JOB NUMBER

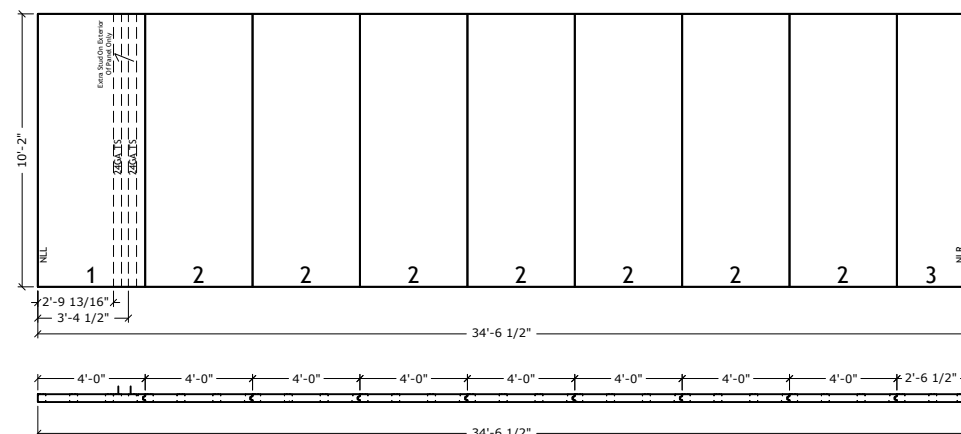

Wall 7
3 1/2" PANELS
24GA TS @ 16" O.C.
 (1.5PSF EPS DENSITY)

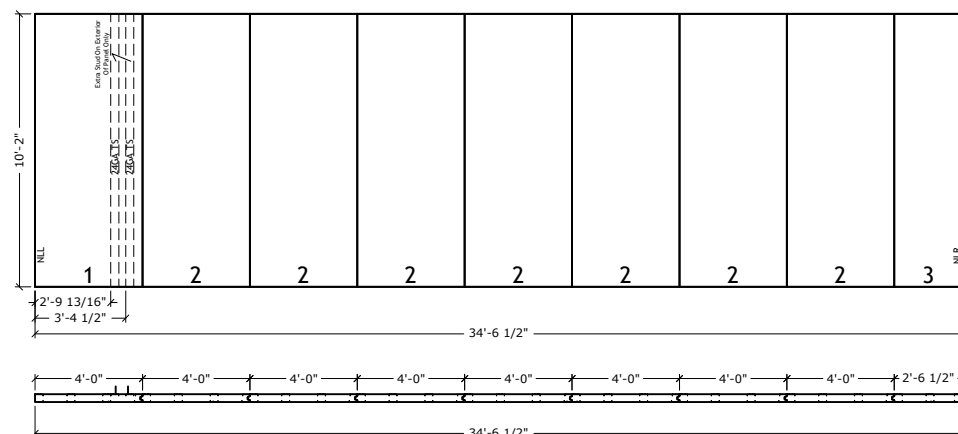

Wall 8
3 1/2" PANELS
24GA TS @ 16" O.C.
 (1.5PSF EPS DENSITY)

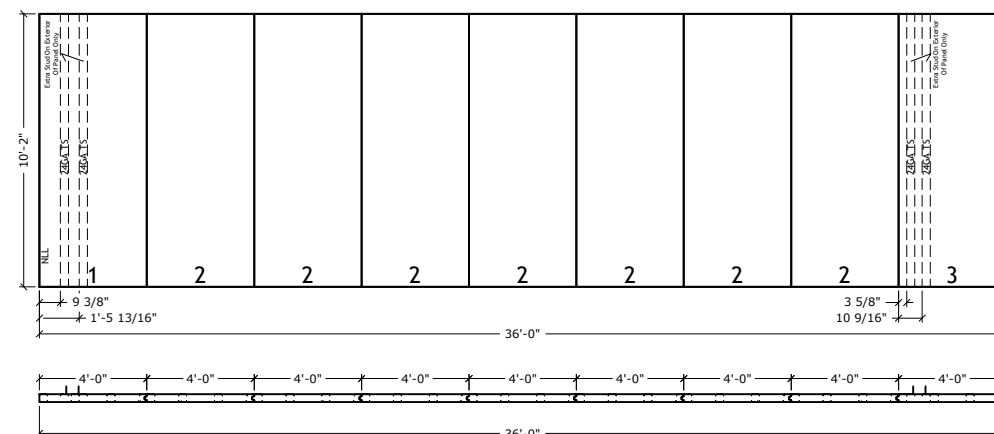


Wall 9
3 1/2" PANELS
24GA TS @ 16" O.C.
 (1.5PSF EPS DENSITY)

Newtown Road Townhomes

FINISH DATE:	5/12/2022
REVISION:	
SCALE:	NTS
DESIGNED:	
DRAWN:	PLiu


THERMASTEEL
 ADVANCED PANEL SYSTEMS

21-245C
JOB NUMBER

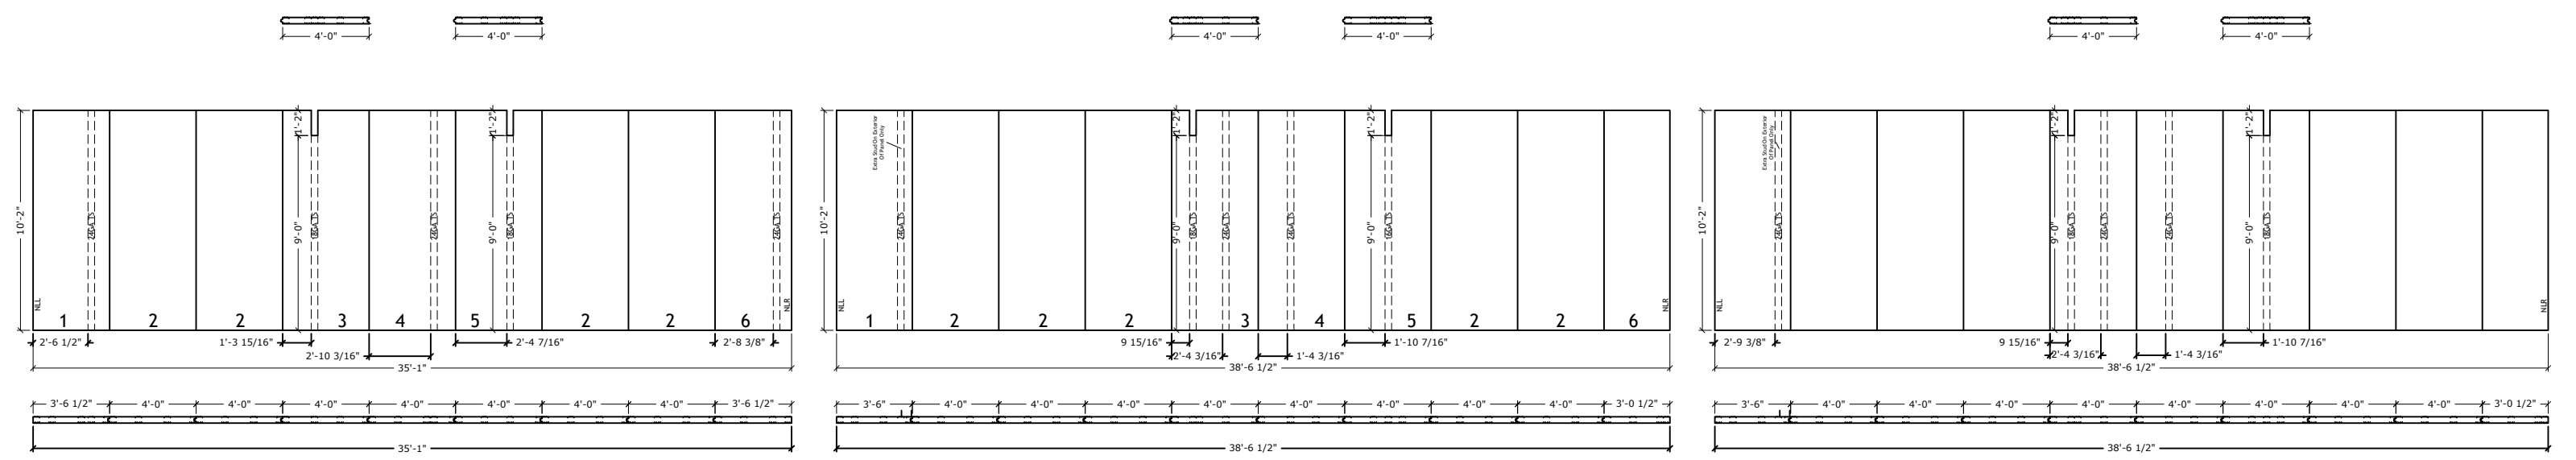

Wall 10
3 1/2" PANELS
24GA TS @ 16" O.C.
(1.5PSF EPS DENSITY)


Wall 11
3 1/2" PANELS
24GA TS @ 16" O.C.
(1.5PSF EPS DENSITY)

Wall 12
3 1/2" PANELS
24GA TS @ 16" O.C.
(1.5PSF EPS DENSITY)


Newtown Road Townhomes

All engineering of the structure, including the ThermaSteel Building System specifications, is to be completed and/or approved by the Project Engineer and/or the Engineer of Record.
THERMASTEEL WALLFRAME SYSTEMS - MANUFACTURED BY THERMASTEEL Inc. - 609 WEST ROCK ROAD RADFORD, VA 24141 - PHONE (540) 633-5000, FAX (540) 633-5001 www.thermasteelinc.com
THE DRAWINGS HEREIN ARE PANEL MANUFACTURING DRAWINGS ONLY. CONTRACTOR SHALL BE SOLELY RESPONSIBLE FOR VERIFYING ALL DIMENSIONS, SITE CONDITIONS, AND THAT ALL STATE AND LOCAL CODE REQUIREMENTS ARE MET.


FINISH DATE:	5/12/2022	<div><div></div><div>THERMASTEEL</div><div>ADVANCED PANEL SYSTEMS</div><div>21-245C</div><div>JOB NUMBER</div></div>
REVISION:		
SCALE:	NTS	
DESIGNED:		
DRAWN:	PLiu	

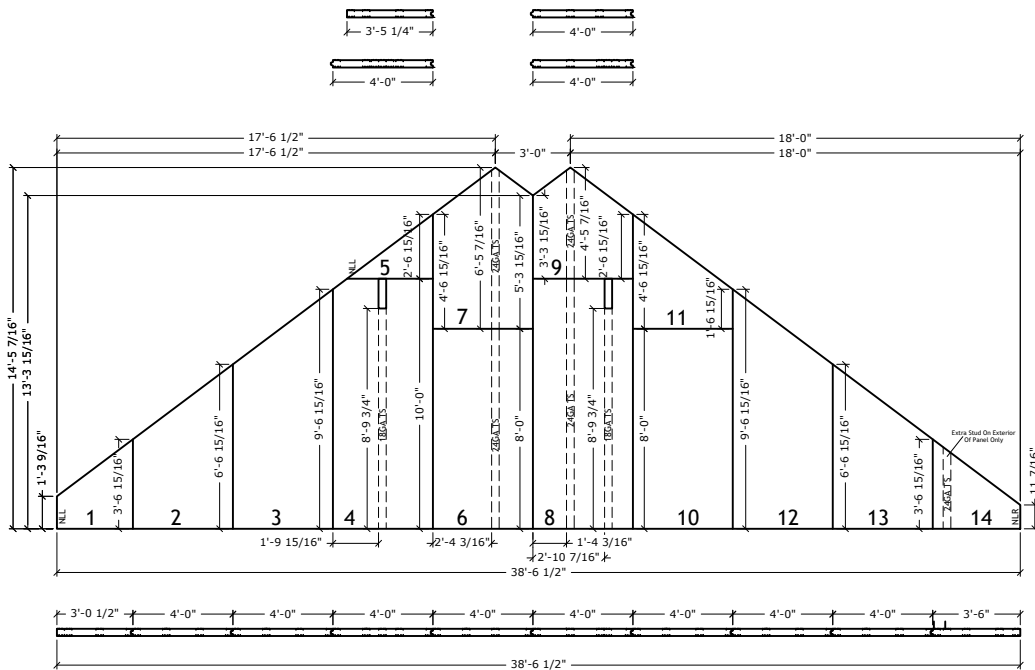

Wall 13
 3 1/2" PANELS
 24GA TS @ 16" O.C.
 (1.5PSF EPS DENSITY)

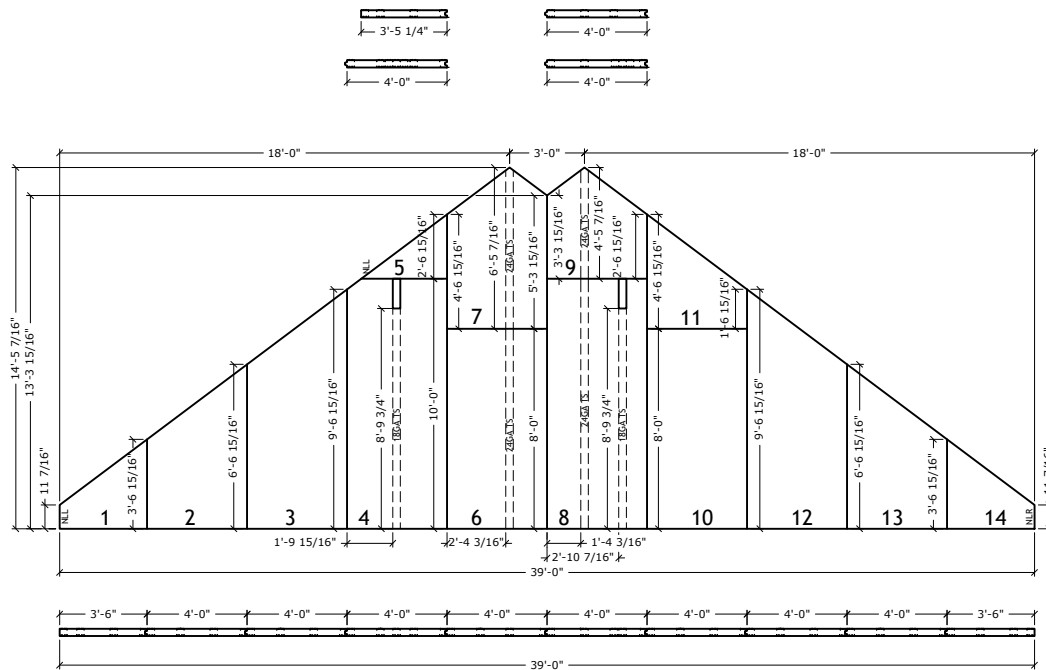

Wall 14
 3 1/2" PANELS
 24GA TS @ 16" O.C.
 (1.5PSF EPS DENSITY)

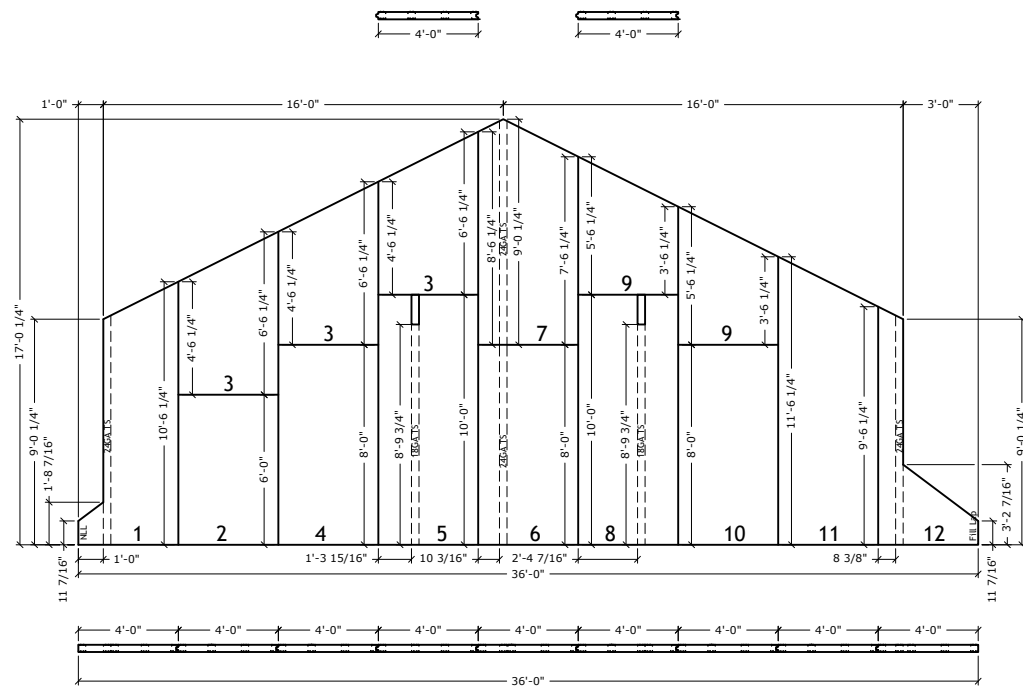

Wall 15
 3 1/2" PANELS
 24GA TS @ 16" O.C.
 (1.5PSF EPS DENSITY)


Newtown Road Townhomes

FINISH DATE:	5/12/2022
REVISION:	
SCALE:	NTS
DESIGNED:	
DRAWN:	PLiu


THERMASTEEL
ADVANCED PANEL SYSTEMS

21-245C


JOB NUMBER

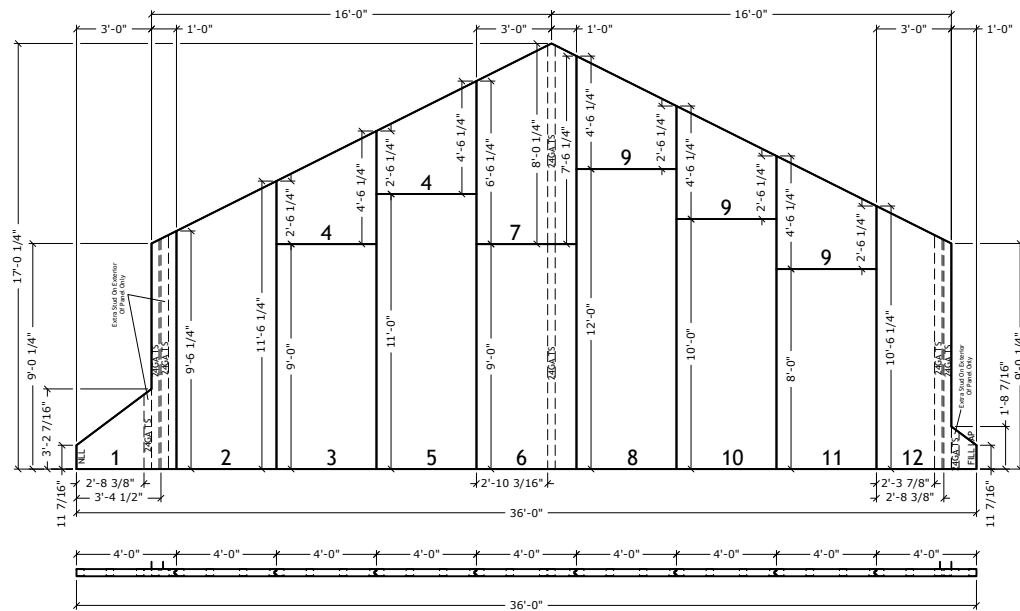

Wall 16
 3 1/2" PANELS
 24GA TS @ 16" O.C.
 (1.5PSF EPS DENSITY)

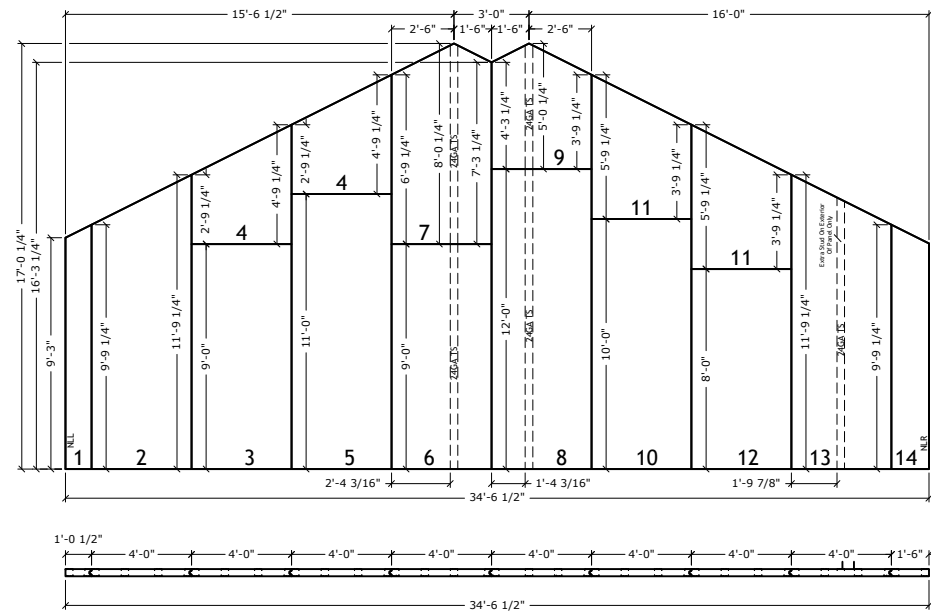

Wall 17
 3 1/2" PANELS
 24GA TS @ 16" O.C.
 (1.5PSF EPS DENSITY)

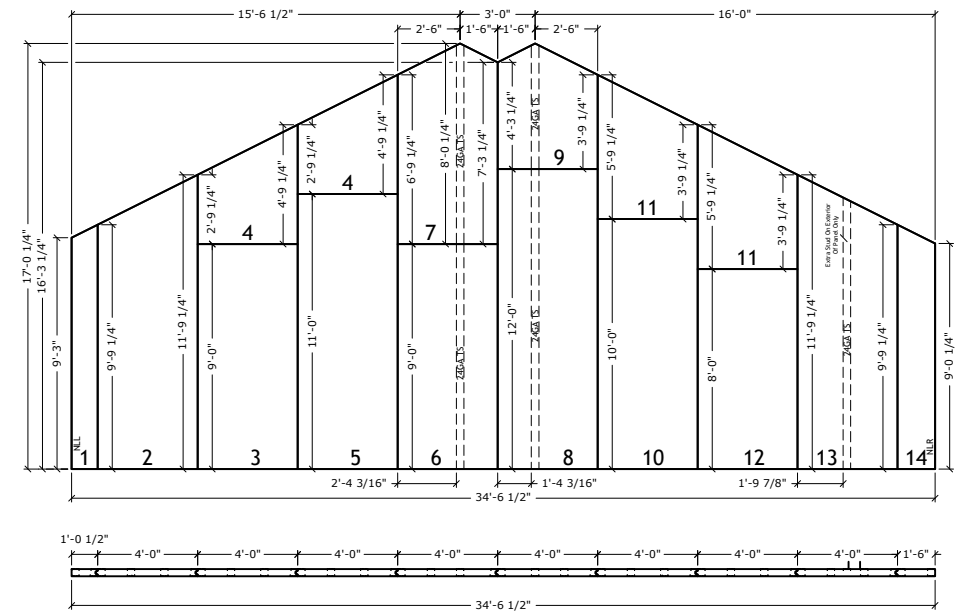


Wall 18
 3 1/2" PANELS
 24GA TS @ 16" O.C.
 (1.5PSF EPS DENSITY)

Newtown Road Townhomes


FINISH DATE:	5/12/2022
REVISION:	
SCALE:	NTS
DESIGNED:	
DRAWN:	PLiu

THERMASTEEL
 ADVANCED PANEL SYSTEMS


21-245C
 JOB NUMBER

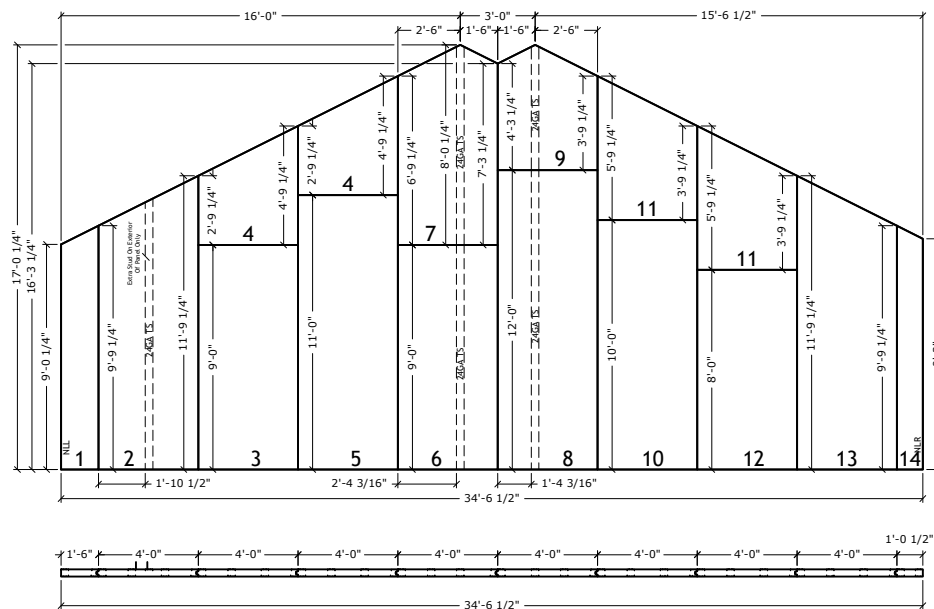

Wall 19
3 1/2" PANELS
24GA TS @ 16" O.C.
(1.5PSF EPS DENSITY)

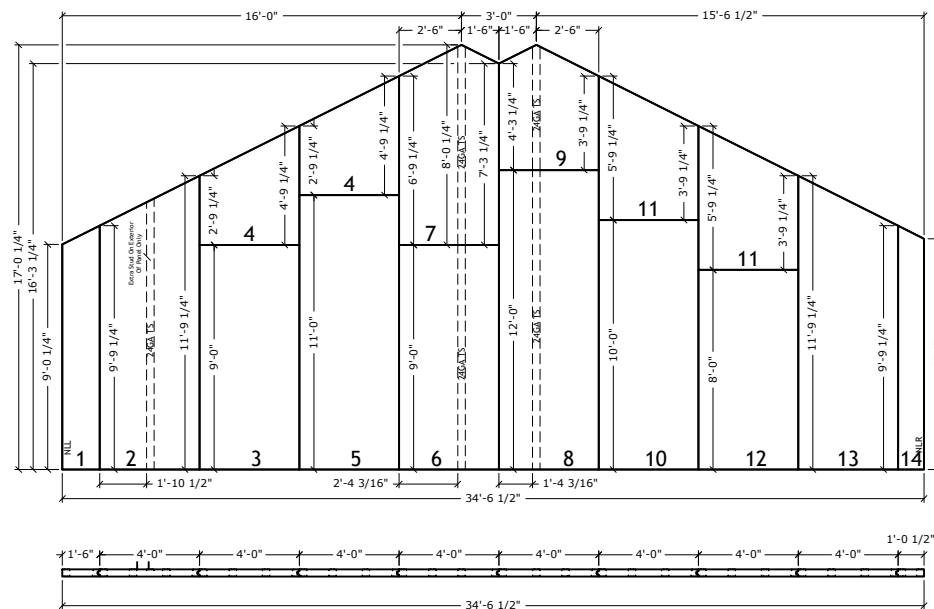

Wall 20
3 1/2" PANELS
24GA TS @ 16" O.C.
(1.5PSF EPS DENSITY)

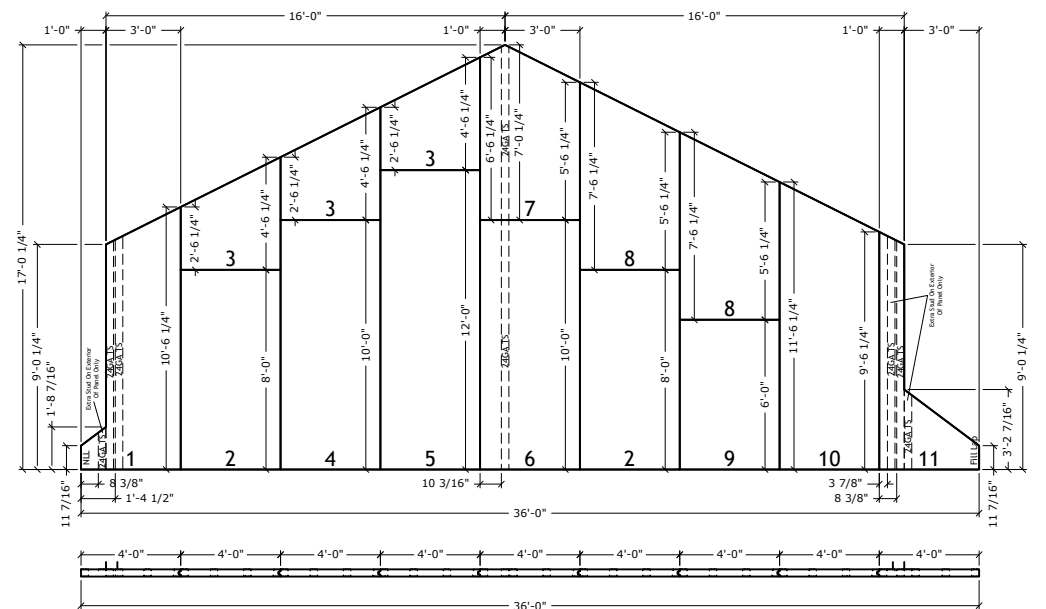


Wall 21
3 1/2" PANELS
24GA TS @ 16" O.C.
(1.5PSF EPS DENSITY)

Newtown Road Townhomes


FINISH DATE:	5/12/2022
REVISION:	
SCALE:	NTS
DESIGNED:	
DRAWN:	PLiu

THERMASTEEL
ADVANCED PANEL SYSTEMS


21-245C
JOB NUMBER

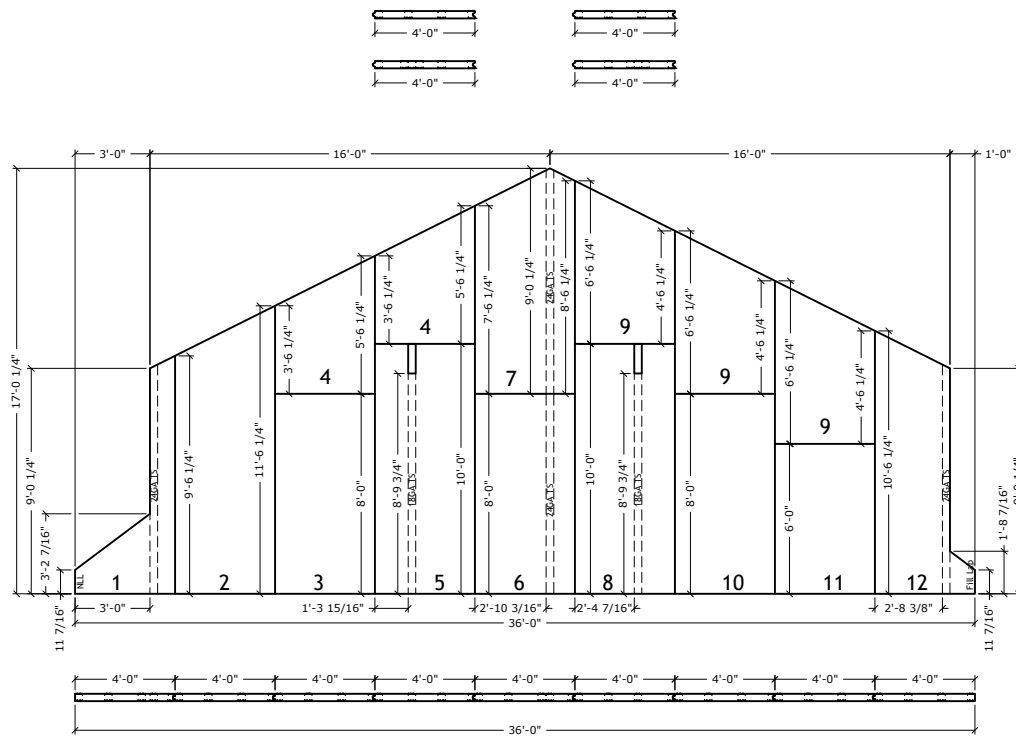

Wall 22
3 1/2" PANELS
24GA TS @ 16" O.C.
(1.5PSF EPS DENSITY)

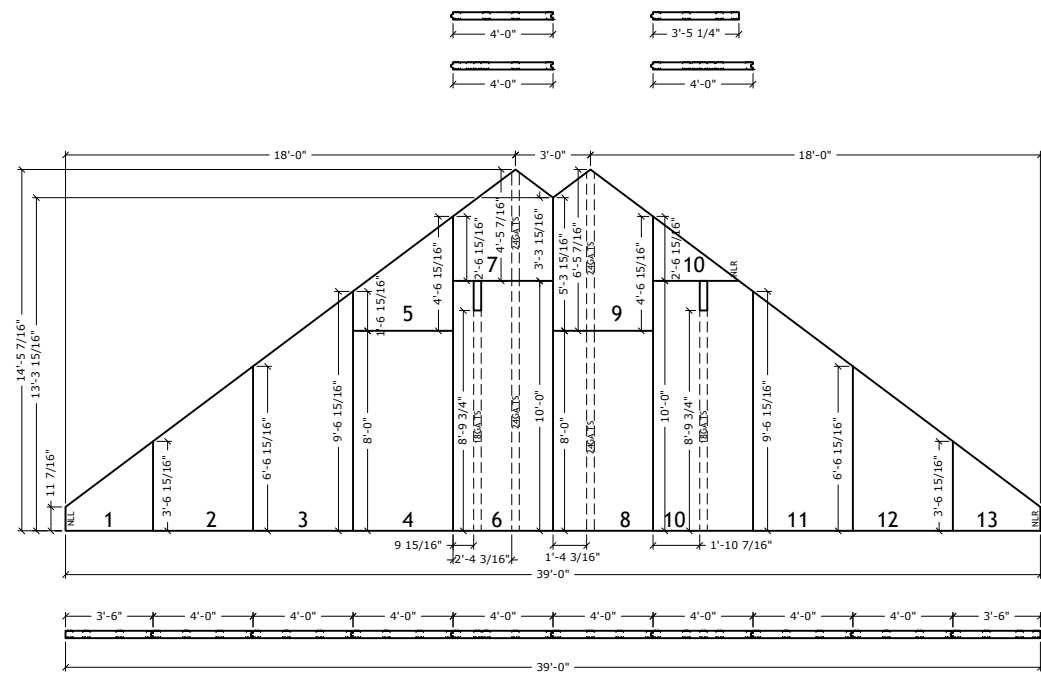

Wall 23
3 1/2" PANELS
24GA TS @ 16" O.C.
(1.5PSF EPS DENSITY)

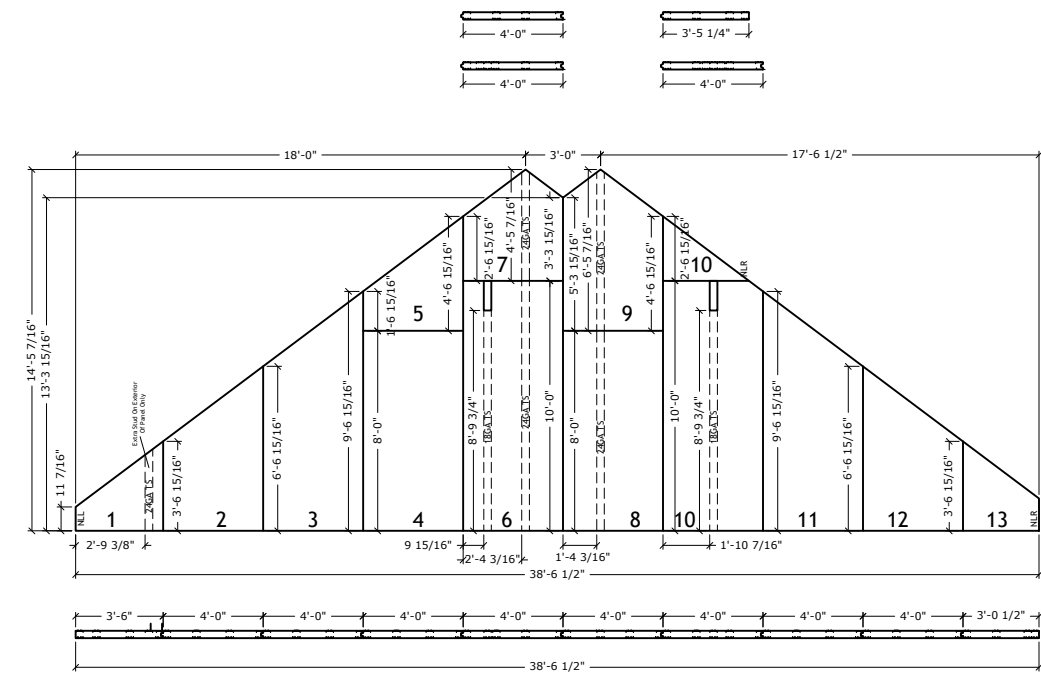

Wall 24
3 1/2" PANELS
24GA TS @ 16" O.C.
(1.5PSF EPS DENSITY)

Newtown Road Townhomes

All engineering of the structure, Including the ThermaSteel Building System specifications, is to be completed and/or approved by the Project Engineer and/or the Engineer of Record.
 THERMASTEEL WALLFRAME SYSTEMS - MANUFACTURED BY THERMASTEEL Inc. - 609 WEST ROCK ROAD RADFORD, VA 24141 - PHONE (540) 633-5000, FAX (540) 633-5001 www.thermasteelinc.com
 THE DRAWINGS HEREIN ARE PANEL MANUFACTURING DRAWINGS ONLY. CONTRACTOR SHALL BE SOLELY RESPONSIBLE FOR VERIFYING ALL DIMENSIONS, SITE CONDITIONS, AND THAT ALL STATE AND LOCAL CODE REQUIREMENTS ARE MET.



FINISH DATE:	5/12/2022
REVISION:	
SCALE:	NTS
DESIGNED:	
DRAWN:	PLiu


THERMASTEEL™
 ADVANCED PANEL SYSTEMS

21-245C
JOB NUMBER


SHEET

17

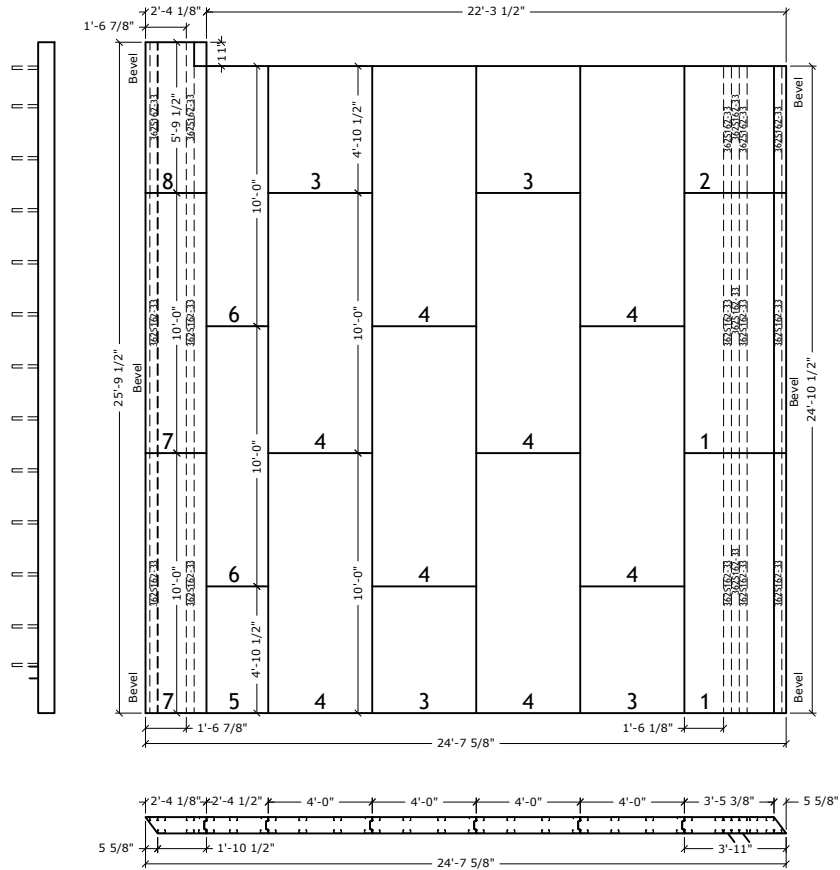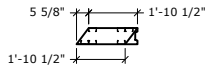


Framing Note:
Roof 1 Panels 1-2 Are To Be
Made Structural Overhang
Panels See Panel Catalog

Roof 1
7 1/2" PANELS
362S162-33 @ 16" O.C.

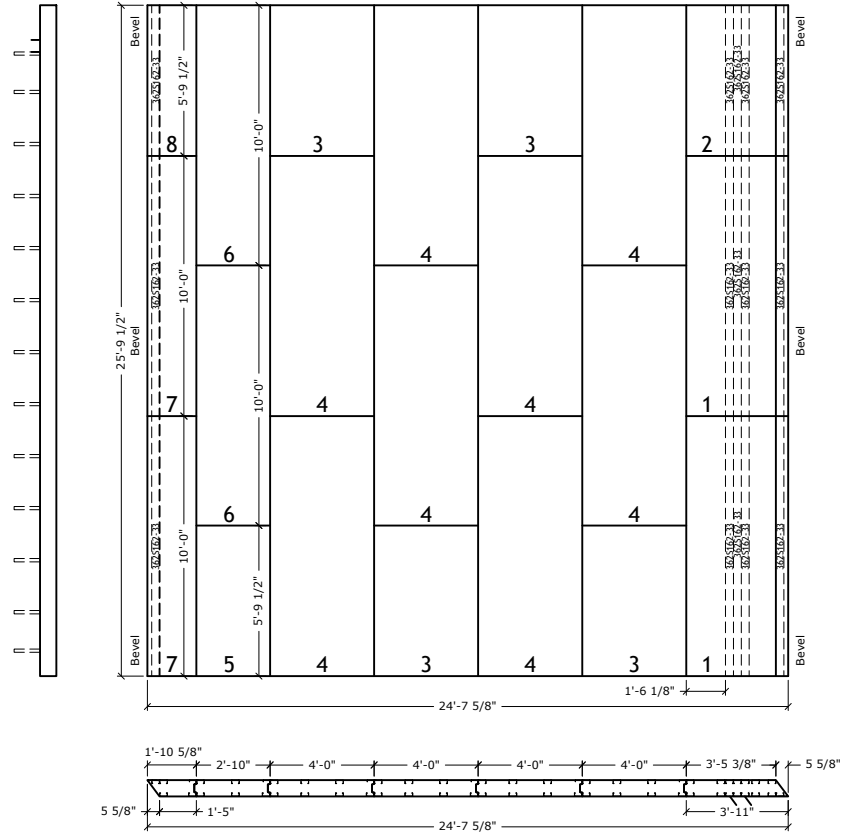


Framing Note:
Roof 2 Panels 1-2 Are To Be
Made Structural Overhang
Panels See Panel Catalog

Roof 2
7 1/2" PANELS
362S162-33 @ 16" O.C.

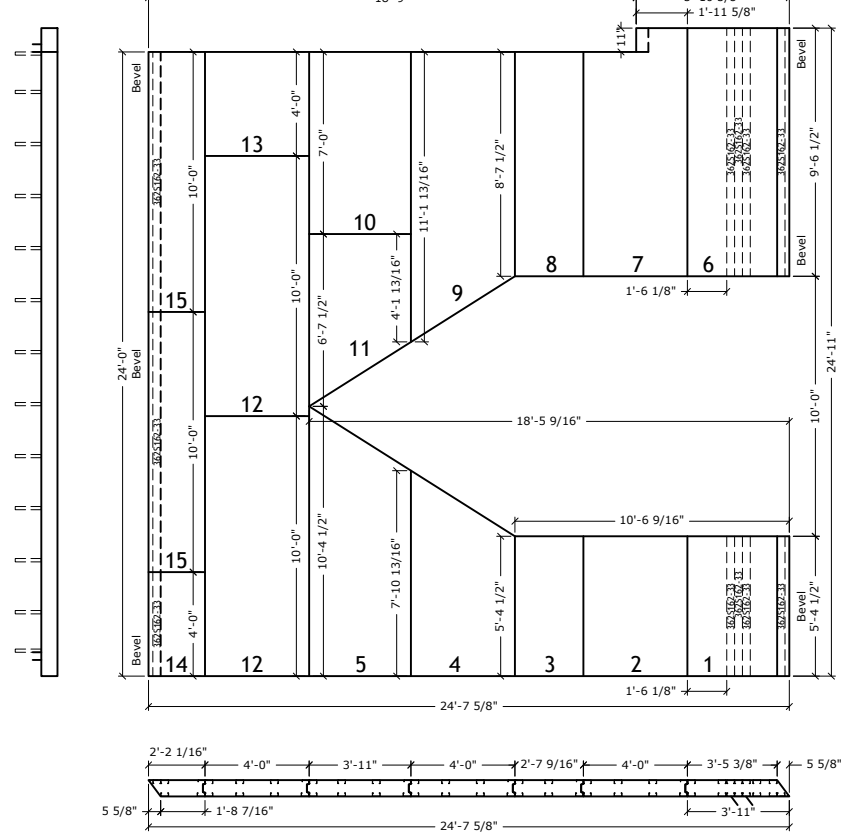

Framing Note:
Roof 3 Panels 1 & 6 Are To Be
Made Structural Overhang
Panels See Panel Catalog

Roof 3
7 1/2" PANELS
362S162-33 @ 16" O.C.

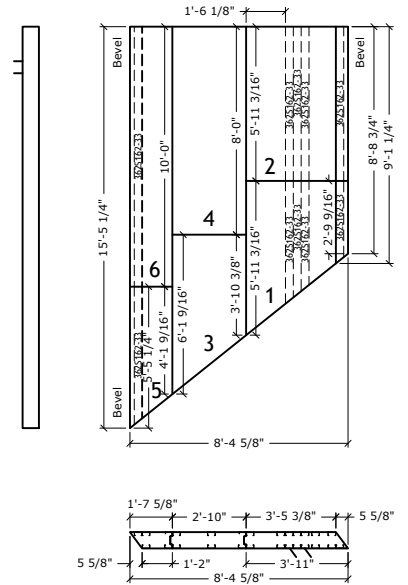

Framing Note:
Roof 4 Panels 1 & 2 Are To Be
Made Structural Overhang
Panels See Panel Catalog

Roof 4
7 1/2" PANELS
362S162-33 @ 16" O.C.

Newtown Road Townhomes

All engineering of the structure, Including the ThermaSteel Building System specifications, is to be completed and/or approved by the Project Engineer and/or the Engineer of Record.
THERMASTEEL WALLFRAME SYSTEMS - MANUFACTURED BY THERMASTEEL Inc. - 609 WEST ROCK ROAD RADFORD, VA 24141 - PHONE (540) 633-5000, FAX (540) 633-5001 www.thermasteelinc.com
THE DRAWINGS HEREIN ARE PANEL MANUFACTURING DRAWINGS ONLY. CONTRACTOR SHALL BE SOLELY RESPONSIBLE FOR VERIFYING ALL DIMENSIONS, SITE CONDITIONS, AND THAT ALL STATE AND LOCAL CODE REQUIREMENTS ARE MET.


FINISH DATE:	5/12/2022
REVISION:	
SCALE:	NTS
DESIGNED:	
DRAWN:	PLiu

**THERMASTEEL™**
ADVANCED PANEL SYSTEMS

21-245C
JOB NUMBER

SHEET

18

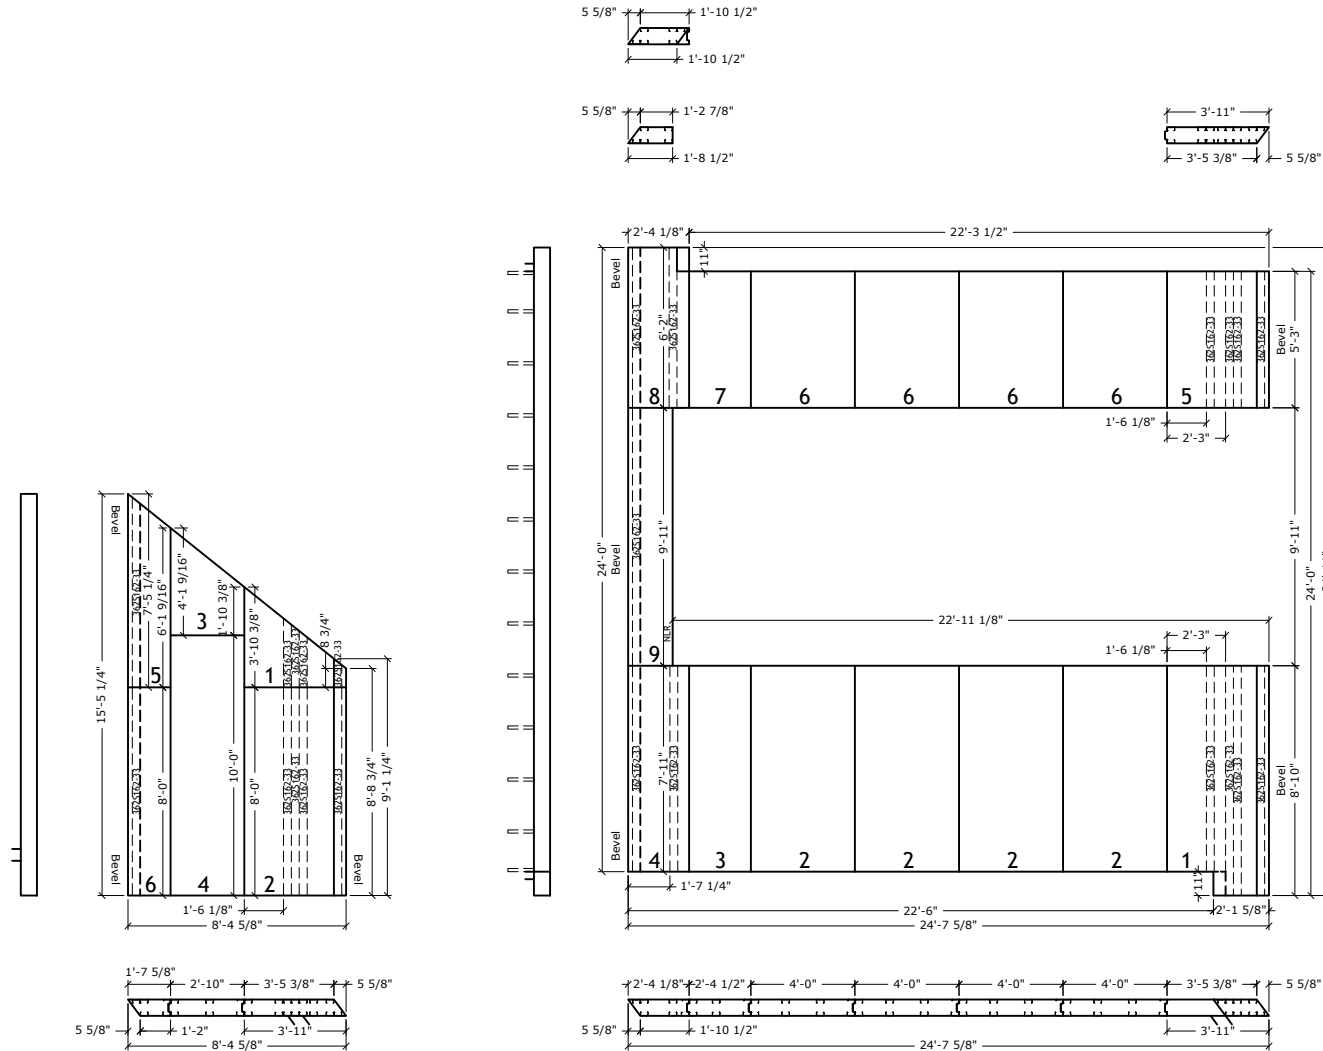


Framing Note:
Roof 5 Panels 1 & 2 Are To Be
Made Structural Overhang
Panels See Panel Catalog

Roof 5
7 1/2" PANELS
362S162-33 @ 16" O.C.


Framing Note:
Roof 6 Panels 1 & 5 Are To Be
Made Structural Overhang
Panels See Panel Catalog

Roof 6
7 1/2" PANELS
362S162-33 @ 16" O.C.

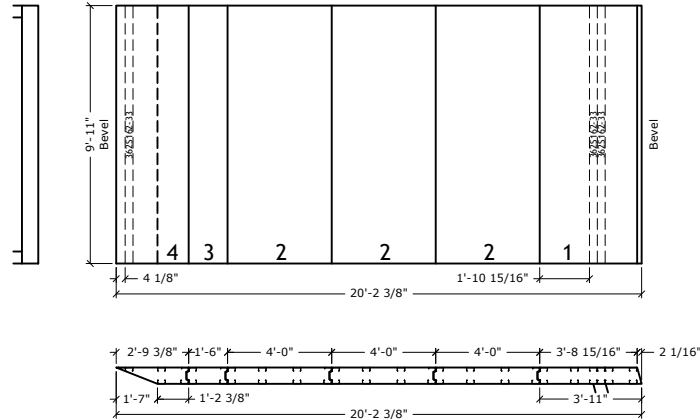

Framing Note:
Roof 7 Panel 1 Is To Be Made
Structural Overhang Panels See
Panel Catalog

Roof 7
7 1/2" PANELS
362S162-33 @ 16" O.C.

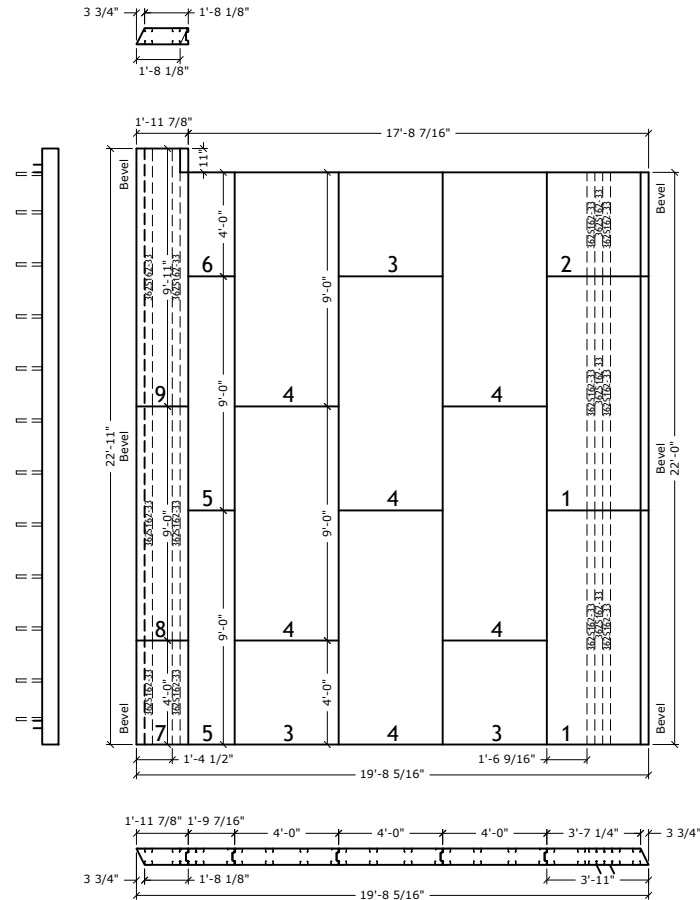

Framing Note:
Roof 8 Panels 1-2 Are To Be
Made Structural Overhang
Panels See Panel Catalog

Roof 8
7 1/2" PANELS
362S162-33 @ 16" O.C.


Newtown Road Townhomes

All engineering of the structure, Including the ThermoSteel Building System specifications, is to be completed and/or approved by the Project Engineer and/or the Engineer of Record.
THERMASTEEL WALLFRAME SYSTEMS - MANUFACTURED BY THERMASTEEL Inc. - 609 WEST ROCK ROAD RADFORD, VA 24141 - PHONE (540) 633-5000, FAX (540) 633-5001 www.thermasteelinc.com
THE DRAWINGS HEREIN ARE PANEL MANUFACTURING DRAWINGS ONLY. CONTRACTOR SHALL BE SOLELY RESPONSIBLE FOR VERIFYING ALL DIMENSIONS, SITE CONDITIONS, AND THAT ALL STATE AND LOCAL CODE REQUIREMENTS ARE MET.

FINISH DATE:	5/12/2022
REVISION:	
SCALE:	NTS
DESIGNED:	
DRAWN:	PLiu

**THERMASTEEL**
ADVANCED PANEL SYSTEMS




21-245C
JOB NUMBER

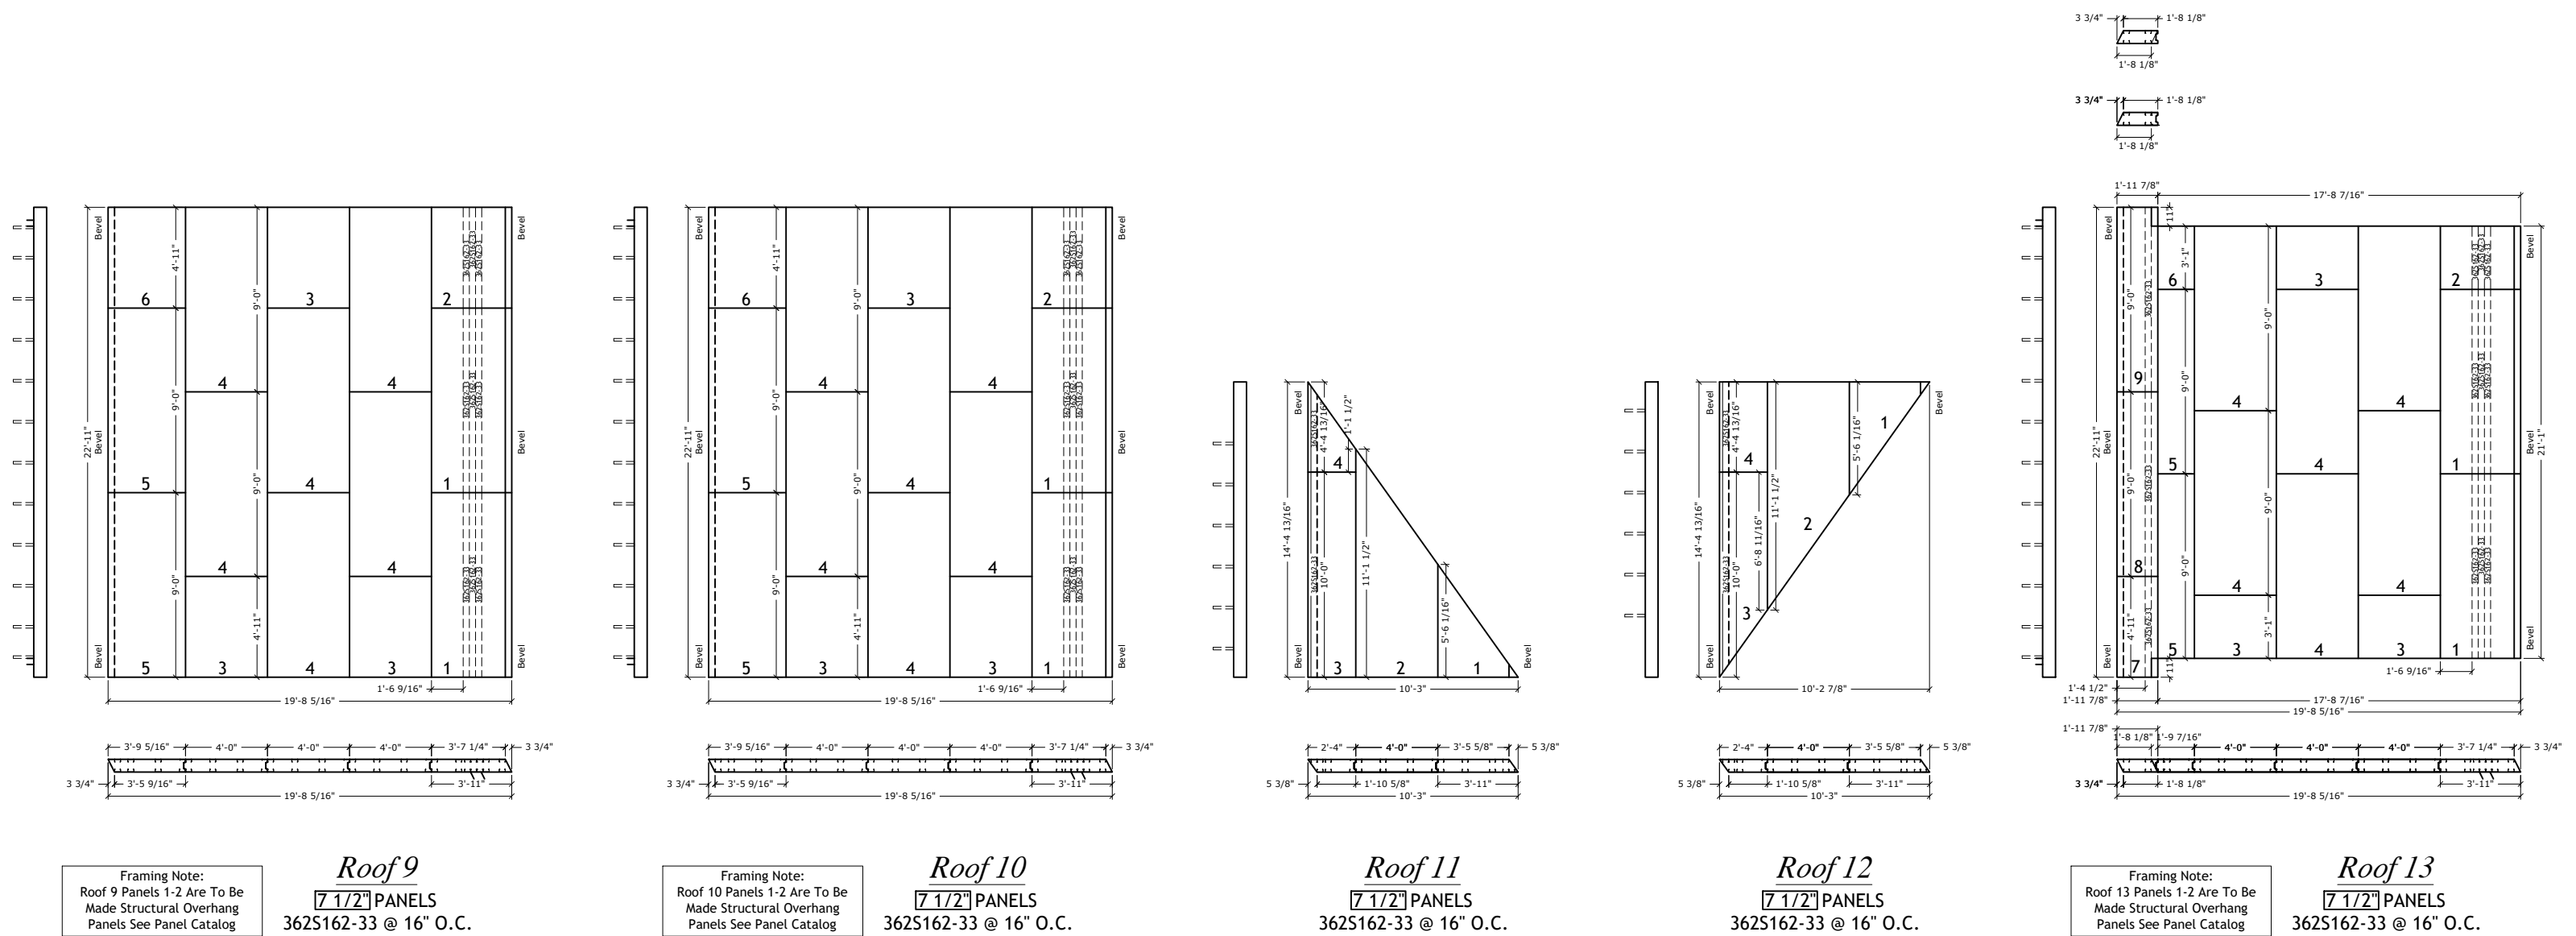

Newtown Road Townhomes


All engineering of the structure, Including the ThermoSteel Building System specifications, is to be completed and/or approved by the Project Engineer and/or the Engineer of Record.
THERMASTEEL WALLFRAME SYSTEMS - MANUFACTURED BY THERMASTEEL Inc. - 609 WEST ROCK ROAD RADFORD, VA 24141 - PHONE (540) 633-5000, FAX (540) 633-5001 www.thermasteelinc.com
THE DRAWINGS HEREIN ARE PANEL MANUFACTURING DRAWINGS ONLY. CONTRACTOR SHALL BE SOLELY RESPONSIBLE FOR VERIFYING ALL DIMENSIONS, SITE CONDITIONS, AND THAT ALL STATE AND LOCAL CODE REQUIREMENTS ARE MET.

FINISH DATE:	5/12/2022	<div><div></div><div>THERMASTEEL</div><div>ADVANCED PANEL SYSTEMS</div></div> <div>21-245C</div> <div>JOB NUMBER</div>	SHEET 20
REVISION:			
SCALE:	NTS		
DESIGNED:			
DRAWN:	PLiu		

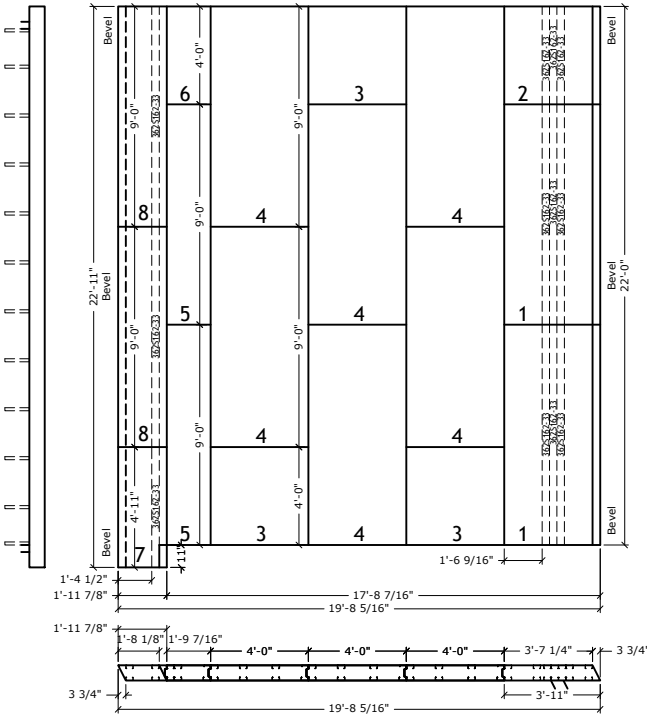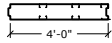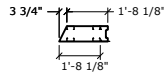


Framing Note:
Roof 14 Panels 1-2 Are To Be
Made Structural Overhang
Panels See Panel Catalog

Roof 14
7 1/2\" PANELS
362S162-33 @ 16\" O.C.

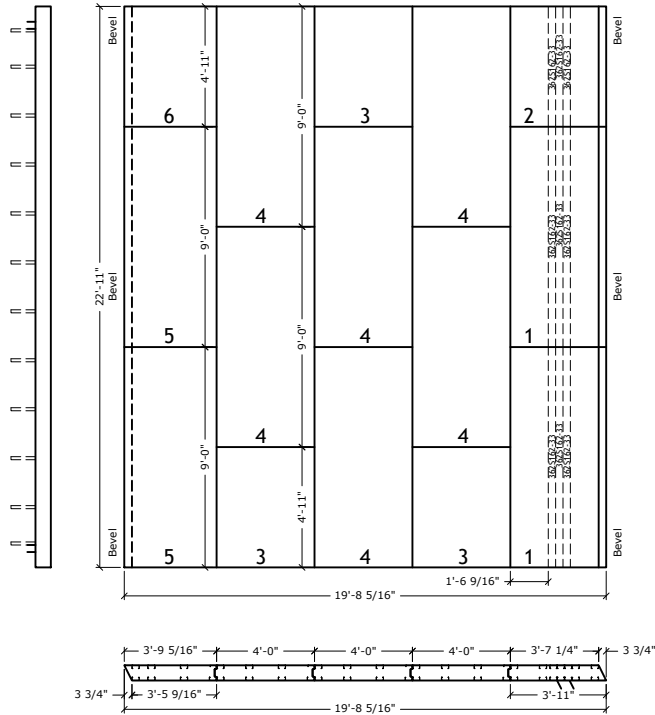


Framing Note:
Roof 15 Panels 1-2 Are To Be
Made Structural Overhang
Panels See Panel Catalog

Roof 15
7 1/2\" PANELS
362S162-33 @ 16\" O.C.

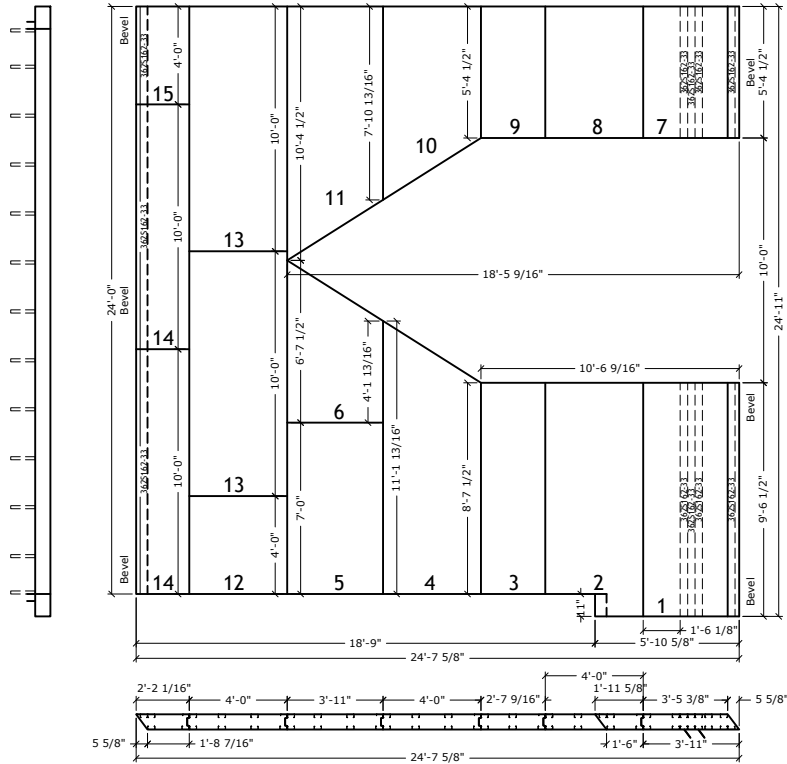


Framing Note:
Roof 16 Panels 1 & 7 Are To Be
Made Structural Overhang
Panels See Panel Catalog

Roof 16
7 1/2\" PANELS
362S162-33 @ 16\" O.C.

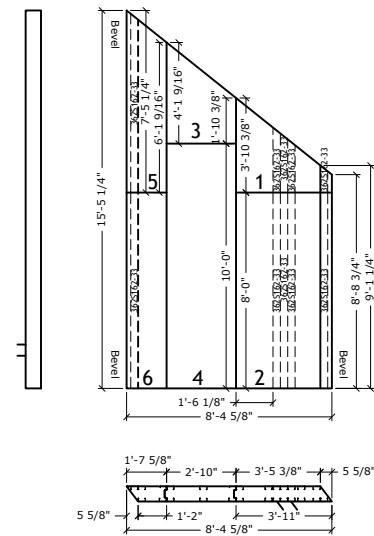

Framing Note:
Roof 17 Panels 1 & 2 Are To Be
Made Structural Overhang
Panels See Panel Catalog

Roof 17
7 1/2\" PANELS
362S162-33 @ 16\" O.C.

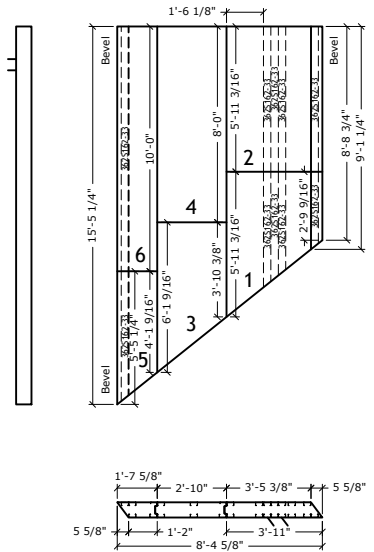

Framing Note:
Roof 18 Panels 1 & 2 Are To Be
Made Structural Overhang
Panels See Panel Catalog

Roof 18
7 1/2\" PANELS
362S162-33 @ 16\" O.C.

Newtown Road Townhomes

All engineering of the structure, Including the ThermaSteel Building System specifications, is to be completed and/or approved by the Project Engineer and/or the Engineer of Record.
THERMASTEEL WALLFRAME SYSTEMS - MANUFACTURED BY THERMASTEEL Inc. - 609 WEST ROCK ROAD RADFORD, VA 24141 - PHONE (540) 633-5000, FAX (540) 633-5001 www.thermasteelinc.com
THE DRAWINGS HEREIN ARE PANEL MANUFACTURING DRAWINGS ONLY. CONTRACTOR SHALL BE SOLELY RESPONSIBLE FOR VERIFYING ALL DIMENSIONS, SITE CONDITIONS, AND THAT ALL STATE AND LOCAL CODE REQUIREMENTS ARE MET.


FINISH DATE:	5/12/2022
REVISION:	
SCALE:	NTS
DESIGNED:	
DRAWN:	PLiu

**THERMASTEEL**
ADVANCED PANEL SYSTEMS

21-245C
JOB NUMBER


SHEET

21

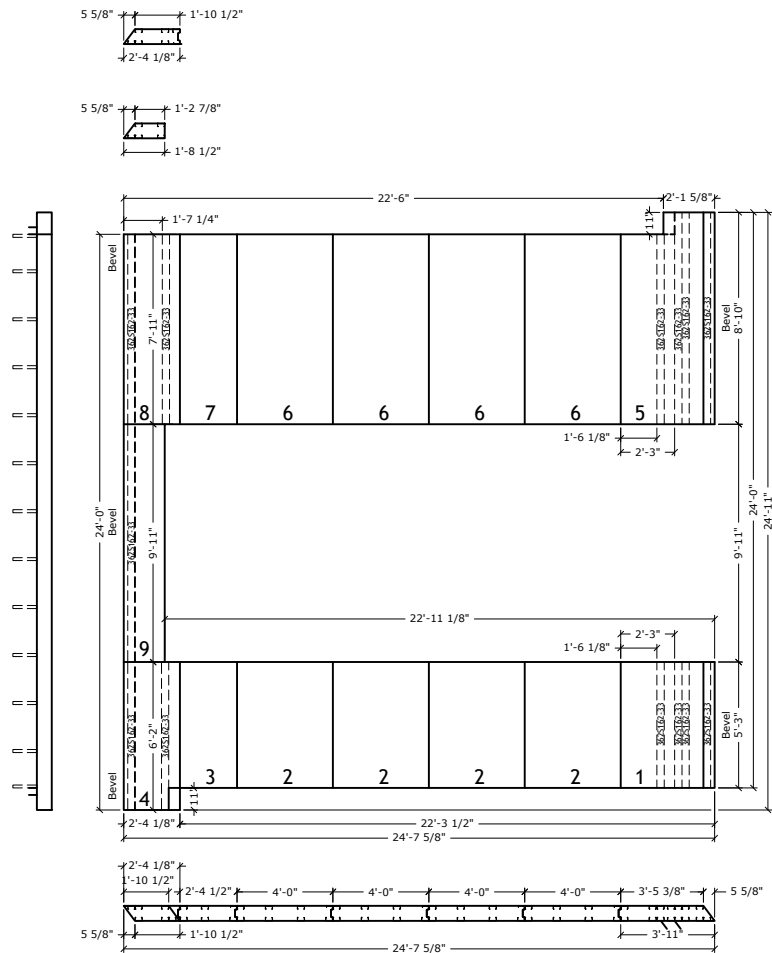


Framing Note:
Roof 19 Panels 1 & 5 Are To Be
Made Structural Overhang
Panels See Panel Catalog

Roof 19
7 1/2" PANELS
362S162-33 @ 16" O.C.

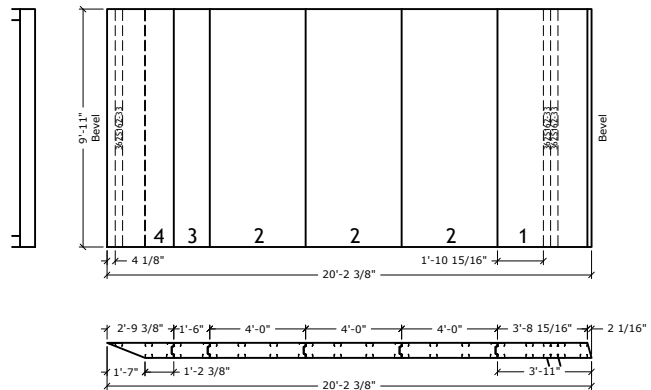


Framing Note:
Roof 20 Panel 1 Is To Be Made
Structural Overhang Panels See
Panel Catalog

Roof 20
7 1/2" PANELS
362S162-33 @ 16" O.C.

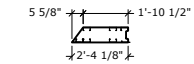

Framing Note:
Roof 21 Panels 1-2 Are To Be
Made Structural Overhang
Panels See Panel Catalog

Roof 21
7 1/2" PANELS
362S162-33 @ 16" O.C.

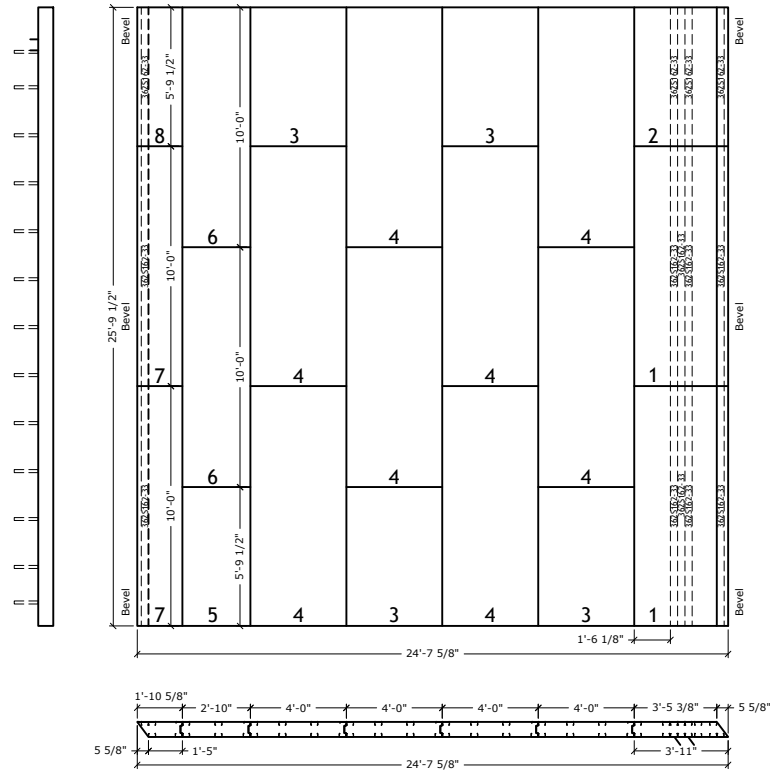

Framing Note:
Roof 22 Panels 1-2 Are To Be
Made Structural Overhang
Panels See Panel Catalog

Roof 22
7 1/2" PANELS
362S162-33 @ 16" O.C.

Newtown Road Townhomes

FINISH DATE:	5/12/2022
REVISION:	
SCALE:	NTS
DESIGNED:	
DRAWN:	PLiu

THERMASTEEL
ADVANCED PANEL SYSTEMS
21-245C
JOB NUMBER